
CONTRA COSTA WATER DISTRICT FISH SCREEN STRUCTURE PHASE 2-LEVEES AND COFFERDAMS CONTRA COSTA CANAL


CENTRAL VALLEY PROJECT IMPROVEMENT ACT, CALIFORNIA

PROJECT NO. 109065

AUGUST 2009

CONFORMED TO INCLUDE ADDENDA

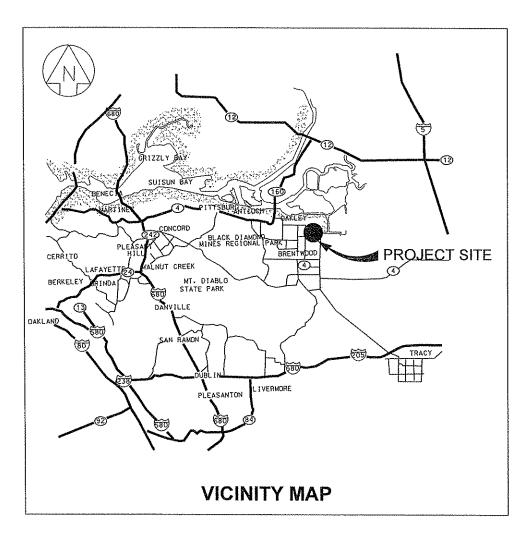


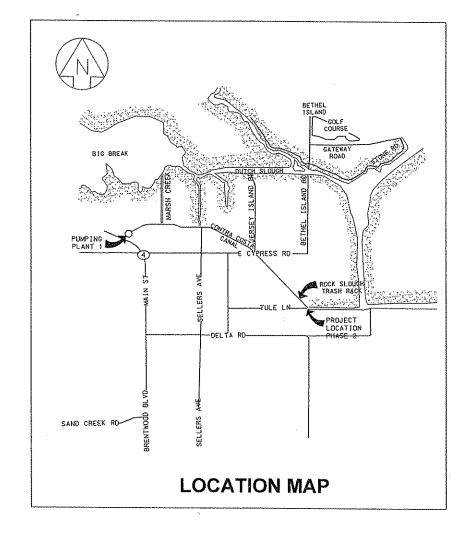


D-13025 D-13026 D-13027 D-13028 D-13029 D-13029A D-13030 D-13031 D-13032	G-1 G-2 G-3 G-4 G-5 G-6 C-1	DRAWING INDEX, LOCATION AND VICINITY MAP GENERAL SYMBOLS AND KEY MAP GENERAL NOTES AND ABBREVIATIONS SITE ACCESS CONSTRUCTION EASEMENTS CONSTRUCTION EASEMENTS
D-13027 D-13028 D-13029 D-13029A D-13030 D-13031 D-13032	G-3 G-4 G-5 G-6 C-1	GENERAL NOTES AND ABBREVIATIONS SITE ACCESS CONSTRUCTION EASEMENTS CONSTRUCTION EASEMENTS
D-13028 D-13029 D-13029A D-13030 D-13031 D-13032	G-4 G-5 G-6 C-1	SITE ACCESS CONSTRUCTION EASEMENTS CONSTRUCTION EASEMENTS
D-13029 D-13029A D-13030 D-13031 D-13032	G-5 G-6 C-1	CONSTRUCTION EASEMENTS CONSTRUCTION EASEMENTS
D-13029A D-13030 D-13031 D-13032	G-6 C-1	CONSTRUCTION EASEMENTS
D-13030 D-13031 D-13032	C-1	
D-13031 D-13032	- '	the second to th
D-13032	0.0	EXISTING SITE PLAN AND SURVEY CONTROL
	C-2	CLEAR AND GRUB LIMITS - DEMO- ACCESS ROAD REPAIR (1 OF
	C-3	CLEAR AND GRUB LIMITS - DEMO - ACCESS REPAIR (2 OF 2)
D-13033	C-4	ENVIRONMENTAL CONSTRAINTS (1 OF 2)
D-13034	C-5	ENVIRONMENTAL CONSTRAINTS (2 OF 2)
D-13035	C-6	GRADING PLAN
D-13036	C-7	EAST AND WEST SETBACK LEVEE PROFILE
D-13037	C-8	EAST LEVEE SECTIONS (1 OF 3)
D-13038	C-9	EAST LEVEE SECTIONS (2 OF 3)
D-13039	C-10	EAST LEVEE SECTIONS (3 OF 3)
D-13040	C-11	WEST LEVEE SECTIONS (1 OF 1)
D-13041	C-12	EAST (ROCK SLOUGH) COFFERDAM SECTION
D-13042	C-13	WEST ROCK SLOUGH EXTENSION COFFERDAM SECTION
D-13043	C-14	NORTH (CONTRA COSTA CANAL) COFFERDAM SECTION
D-13044	C-15	COFFERDAM DETAILS
D-13045	C-16	CIVIL DETAILS 1
D-13046	C-17	CIVIL DETAILS 2 IRRIGATION STANDPIPE
D-13047	C-18	CIVIL DETAILS 3
D-13048	C-19	CIVIL DETAILS 4
D-13049	C-20	TEMPORARY IRRIGATION AND BYPASS PUMPING PLAN
D-13050	C-21	WATER QUALITY STATION
D-13051	C-22	FENCING DETAILS
	C-23	PHOTOS
	D-13036 D-13037 D-13038 D-13039 D-13040 D-13041 D-13042 D-13043 D-13044 D-13045 D-13046 D-13047 D-13048 D-13049 D-13049	D-13036 C-7 D-13037 C-8 D-13038 C-9 D-13039 C-10 D-13040 C-11 D-13041 C-12 D-13042 C-13 D-13043 C-14 D-13044 C-15 D-13045 C-16 D-13046 C-17 D-13047 C-18 D-13048 C-19 D-13049 C-20 D-13050 C-21



DESIGN BY: M. MAHER CHECKED BY: P. BELLOWS DRAWN BY: F. BURKE CHECKED BY: C. JOYCE

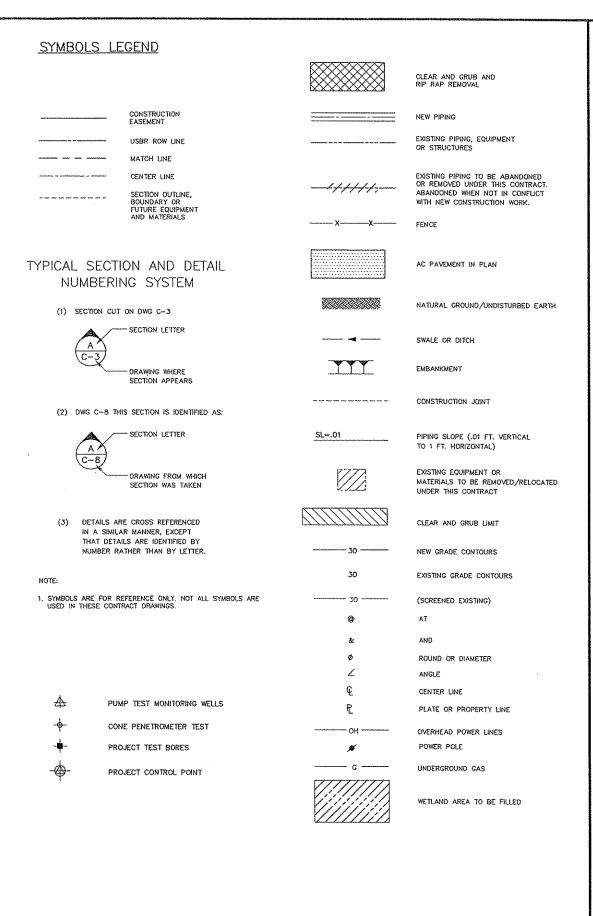

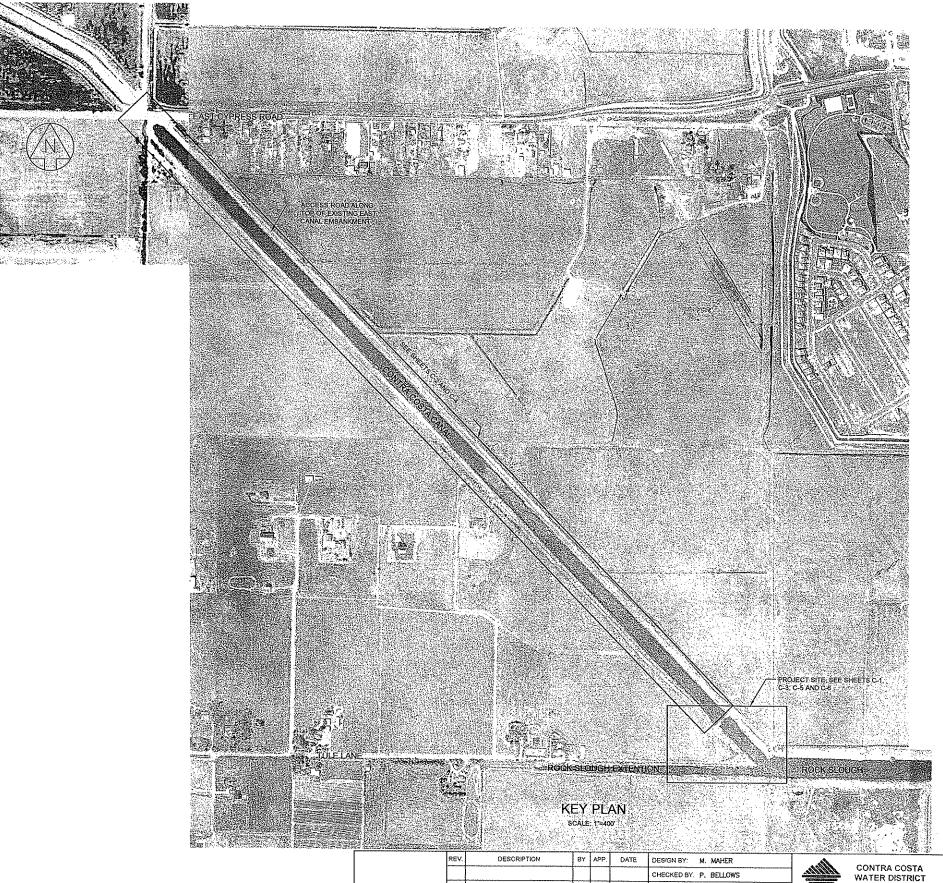

CONFORMED

LINE IS 2 INCHES

DATE: 07/13/2009

DRAWN BY: F. BURKE CHECKED BY: C. JOYCE PROJECT NO.: AS SHOWN CAL GRID: ASSESSOR'S BOOK ONFORMED TO INCLUDE ADDENDA CAD FILE: D-X-FSPH1-GZ

FISH SCREEN STRUCTURE PHASE 2 LEVEES AND COFFERDAMS CONTRA COSTA CANAL, CVPIA, CA GENERAL SYMBOLS AND KEY

D-13026

BROWN AND CALDWELL

CONTRA COSTA WATER DISTRICT CONCORD, CALIFORNIA

G-3

FISH SCREEN STRUCTURE PHASE 2 LEVEES AND COFFERDAMS CONTRA COSTA CANAL, CVPIA, CA

GENERAL NOTES AND ABBREVIATIONS
DRAWING CONSULTANT REV.

NO.

D-13027

CHECKED BY: C. JOYCE PROJECT NO.

AS SHOWN

ASSESSOR'S BOOK

PLOT DATE: 9/23/2009 11:24 AM

109065

CAD FILE: D-X-FSPH1-G3

CAL GRID:

08/2009

CONFORMED TO INCLUDE ADDENDA

ISSUED FOR BID

GENERAL NOTES

1. THE LOCATION, MATERIAL INDICATED, AND/OR ELEVATIONS OF UNDERGROUND UTILITIES SHOWN ON THE DRAWINGS AND REFERENCE DRAWINGS ARE APPROXIMATE ONLY. INFORMATION WAS TAKEN FROM PLANS AND RECORDS OF THE VARIOUS UTILITIES AND AGENCIES. IT SHALL BE THE RESPONSIBILITY OF THE CONTRACTOR TO CONTACT ALL UTILITY COMPANIES SO THAT THOSE COMPANIES MAY MARK THE LOCATIONS OF THEIR LINES PRIOR TO EXCAVATION. THE CONTRACTOR SHALL NOTIFY UNDERGROUND SERVICE ALERT (USA) AT (800) 227—2600 AT LEAST TWO WORKING DAYS BEFORE EXCAVATING. THE CONTRACTOR SHALL BE RESPONSIBLE TO OBTAIN ALL NECESSARY APPROVALS AND/OR PERMITS, PROTECT THE EXISTING FACILITIES, AND TO FIELD VERIFY THE LOCATION AND DEPTH OF EXISTING UTILITIES

ETS ELECTROLYSIS TEST STATION CONFORMED

AT FULL SIZE (# NOT 2"-SCALE ACCORDINGLY)

BROWN AND

CALDWELL


- 2. CONTRACTOR SHALL PROVIDE SUPPORT FOR ALL UTILITIES EXPOSED DURING CONSTRUCTION
- 3. CONTRACTOR SHALL PROTECT ALL EXISTING IMPROVEMENTS NOT DESIGNATED FOR DEMOLITION AND REMOVAL AND REPLACEMENT. ALL DAMAGED EXISTING IMPROVEMENTS AND THOSE IMPROVEMENTS WHICH HAVE BEEN REMOVED OR TEMPORARILY RELOCATED SHALL BE RESTORED BY THE CONTRACTOR TO A CONDITION EQUAL OR BETTER THAN PRIOR TO CONSTRUCTION. IMPROVEMENTS DESIGNATED FOR DEMOLITION SHALL BE DEMOLISHED AND DISPOSED OF BY THE
- 4. PROPERTY LINES INCLUDED IN THESE DRAWINGS ARE ONLY A GRAPHIC REPRESENTATION OF AVAILABLE PUBLIC RECORD. THEIR LOCATIONS ARE NOT BASED ON FIELD SURVEYS, IN-DEPTH RESEARCH OR ANALYSIS OF LEGAL DOCUMENTS. A FORMAL COMPREHENISME BOUNDARY SURVEY WAS NOT PERFORMED TO DETERMINE THE EXACT LOCATIONS OF PROPERTY LINES. CONTRACTOR SHALL STAKE PROPERTY LINES AND EASEMENTS ACCORDING TO THE PLAT MAP AND LEGAL DESCRIPTIONS INCLUDED IN APPENDIX C IN THE PROJECT SPECIFICATIONS, AND DRAWING G-5.
- CONTOURS FOR THE BOTTOM OF CHANNEL NORTH OF ROCK SLOUGH TRASH RACK WERE DERIVED FROM CROSS SECTIONS(SOUNDINGS) TAKEN AT 200 FT. INTERVALS ALONG THE CANAL.
- 6. THE AERIAL TOPOGRAPHY FROM CYPRESS ROAD TO THE TRASH RACK SHOWN HEREON WAS PROVIDED BY HAMMON, JENSEN, WALLEN & ASSOCIATES, INC. (DATE OF PHOTOGRAPHY WAS MARCH 23, 2006.) AND INFORMATION FOR THE TRASH RACK TO AND INCLUDING ROCK SLOUGH WAS PROVIDED BY CCWD AND USBR. PORTIONS OF THE TOPOGRAPHY ARE EXTRAPOLATION OF ADJACENT LANDS AND WERE NOT SURVEYED AS PART OF THE DESIGN.
- 7. THE CONTRACTOR SHALL CLEAR AND GRUB PER SPEC SECTION 02111 AND WHERE SHOWN ON THE PLANS,
- 8. USCG-APPROVED PERSONAL FLOTATION DEVICE/WATER SAFETY FOR CANALS WHEN ENOUGH WATER IS PRESENT FOR EMERSION OR ENGULTMENT HAZARD, ANY INDIVIDUAL ENTERING INSIDE THE PERIMETER OF THE LINED OR UNLINED CONTRA COSTA CANAL MUST WEAR A FLOTATION DEVICE AT ALL TIMES. THIS AREA INCLUDES, BUT IS NOT LIMITED TO, THE BANKS OF THE UNLINED CANAL, ROCK SLOUGH, WATER QUALITY MONITORING STATION, AND STRUCTURES SUCH AS THE ROCK SLOUGH TRASH RACK THAT CROSSES OVER THE CANAL.
- CONTRACTOR SHALL PERFORM THE REQUIRED WORK TO COMPLETE THE PROJECT ACCORDING TO THE SEQUENCE AND CONSTRAINTS LISTED IN SPEC SECTION 01010, SECTION 01060, AND ASSOCIATED PERMITS OBTAINED FOR THIS
- 10. CONTRACTOR SHALL MAINTAIN VERTICAL AND HORIZONTAL CLEARANCES OF 15 FEET FROM WAPA AND 10 FEET FROM PG&E OVERHEAD POWER LINES, CONTRACTOR TO CONTACT WPA TO OBTAIN ACTUAL CLEARANCE OF OVERHEAD 69 KV
- 11. PROJECT AREA MAY CONTAIN ENDANGERED OR THREATENED SPECIES INCLUDING, BUT NOT LIMITED TO, GIANT GARTER SNAKE, BURROWING OWL NESTS AND NESTING RAPTORS. DISTRICT WILL PERFORM A BIOLOGICAL SURVEY BEFORE AND DURING CONSTRUCTION. CONTRACTOR SHALL NOTIFY THE CONSTRUCTION ADMINISTRATOR IF ANY PROTECTED SPECIES ARE FOUND DURING CONSTRUCTION. ADJUST WORK AS DIRECTED BY CONSTRUCTION ADMINISTRATOR TO AVOID DISRUPTION OF SPECIES. SEE SPECIFICATION SECTION 01060. ALL CONTRACTOR PERSONNEL SHALL UNDERGO ENVIRONMENTAL AWARENESS TRAINING PRIOR TO PARTICIPATION IN CONSTRUCTION PER SPEC SECTION 01060.
- 12. CONTRACTOR SHALL CONFINE WORK TO USBR ROW AND IDENTIFIED TEMPORARY CONSTRUCTION EASEMENTS.
- 13. CONTRACTOR SHALL REFER TO SPEC SECTION 01060 AND APPENDIX C OF SPECIFICATIONS TO BECOME FAMILIAR WITH CONSTRUCTION EASEMENT REQUIREMENTS AND RESTRICTIONS
- 14. CONTRACTOR IS ADVISED THAT ACCESS TO ALL OR PORTIONS OF THE SITE MAY BE LIMITED DURING WET WEATHER.
- 15. PG&E TO RELOCATE POWER POLES. CONTRACTOR SHALL COORDINATE ACTIVITIES WITH PG&E. CONTRACTOR SHALL PROVIDE "CAUTION OVERHEAD ELECTRIC" SIGNS TO IDENTIFY OVERHEAD POWERLINES.
- 16. WAPA LINES TO BE PROTECTED BY THE CONTRACTOR. CONTRACTOR TO COORDINATE CONSTRUCTION ACTIVITIES WITH WAPA AND SHALL PROVIDE "CAUTION OVERHEAD ELECTRIC" SIGNS TO IDENTIFY OVERHEAD POWERLINES.

VADIZI	EVIATIONS				
AASHTO	AMERICAN ASSOCIATION OF STATE HIGHWAY TRANSPORTATION OFFICIALS	EST	ESTIMATE	POE	PLAIN ONE END
	AGGREGATE BASE	EW EXIST	EACH WAY EXISTING	PP	POWER POLE
A/B	AS BUILT			PP1	PUMPING PLAN NO. 1
AC	ASPHALT CONCRETE OR ASBESTOS CEMENT	FC	FACE OF CURB	PRV	PRESSURE REDUCING VALVE
ACI	AMERICAN CONCRETE INSTITUTE	FDP	FEEDER DISTRIBUTION PANEL	PS	PUMPING STATION
Al	ASPHALT INSTITUTE	FE	FEMALE END	PSI	POUNDS PER SQUARE INCH
AlA	AMERICAN INSTITUTE OF ARCHITECTS	FH	FIRE HYDRANT	PVC	POLYMNYL CHLORIDE
ANSI	AMERICAN NATIONAL STANDARDS INSTITUTE	FBE	FLANGED BOTH ENDS	R	RADIUS
API	AMERICAN PETROLEUM INSTITUTE	FL.	FLOW LINE	RD	RECLAMATION DISTRICT
AISI	AMERICAN IRON & STEEL	FLG	FLANGE	REINF	REINFORCEMENT
AISC	AMERICAN INSTITUTE OF STEEL CONSTRUCTION	FOE FS	FLANGED ONE END FINISHED SURFACE	RI	RODDING INLET
APN	ASSESSOR'S PARCEL NUMBER	FT	FEET	RET	RETURN
APWA	AMERICAN PUBLIC WORKS ASSOCIATION			RD	ROAD
APPROX	APPROXIMATELY	G G	GAS	RCP	REINFORCED CONCRETE PIPE
AR	AIR RELIEF	GALV	GALVANIZED	ROW	RIGHT OF WAY
AREA	AMERICAN RAILWAY ENGINEERING ASSOCIATION	GΛ	GATE VALVE	RR	RUBBER RING, RAILROAD
	AMERICAN STANDARDS ASSOCIATION	H	HORIZONTAL	RT	RING-TITE
ASCE	AMERICAN SOCIETY OF CIVIL ENGINEERS	HE	HUB END	RW	RAW WATER
ASME	AMERICAN SOCIETY OF MECHANICAL ENGINEERS	HGL	HYDRAULIC GRADE LINE	RWW	RAW WATER VAULT
ASSY	ASSEMBLY	HHW	HIGHER HIGH WATER	s	SLOPE
ASTM	AMERICAN SOCIETY FOR TESTING MATERIALS	HP	HIGH POINT	SAE	SOCIETY OF AUTOMOTIVE ENGINEERS
AVG	AVERAGE	HWY	HIGHWAY	scc	STEEL PIPE, CEMENT LINED, CEMENT COATED
AWS	AMERICAN WELDING SOCIETY	ID OI	INSIDE DIAMETER	SCH	SCHEDULE
AWWA	AMERICAN WATER WORKS ASSOCIATION	IEEE	INSTITUTE OF ELECTRICAL AND ELECTRONIC ENGINEERS	SCM	STEEL PIPE, CEMENT LINED, ASPHALT MASTIC CO.
B&S	BELL & SPIGOT	inv	INVERT	SCW	STEEL TAPE WRAPPED PIPE
B/SW	BACK OF SIDEWALK	₽	IRON PIPE	SD	STORM DRAIN
BC	BEGINNING OF CURVE	IPCEA	INSULATED POWER CABLE ENGINEERS' ASSOCIATION	SEB	SMALL END BELL
вм	BENCH MARK	ISD	IRONHOUSE SANITARY DISTRICT	SHT	SHEET
во	BLOW-OFF	JO	JOB ORDER	SPEC	SPECIFICATION
BFV	BUTTERFLY VALVE	JP	JOINT POLE	SQ	SQUARE
BM	BOTTOM OF WALL			SS	STAINLESS STEEL
CCCFCD	CONTRA COSTA COUNTY FLOOD CONTROL DISTRICT	ΚV	KILOVOLT	STA	STATION
CCWD	CONTRA COSTA WATER DISTRICT	£	LENGTH	STO	STANDARD
CDF	CONTROLLED DENSITY FILL	LEB	LARGE END BELL	STL	STEEL
CB	CATCH BASIN	LOL	LAYOUT LINE	S₩	SOLVENT WELD
CDF	CONTROL DENSITY FILL	Lp	PROJECTED LENGTH	s/w	SIDEWALK
CIOD	CAST IRON OUTSIDE DIAMETER	MA	MALE END	Ť	TELEPHONE
CIP	CAST IRON OUTSIDE DIAMETER	MAX	MAXIMUM	T&B	TOP AND BOTTOM
		MCP	MONOLITHIC CONCRETE POUR	TBE	THREADED BOTH ENDS
CIPP CL	CAST IN PLACE PIPE CENTERLINE	MD	MAIN DISCONNECT	ТВМ	TEMPORARY BENCH MARK
CMP	CORRUGATED METAL PIPE	мн	MANHOLE	TBO	TEMPORARY BLOW-OFF
CO	CLEAN OUT	MON	MONUMENT	TC	TOP OF CURB OR TANGENT TO CURVE
CONT	CONTINUATION	ME	MILLED EACH END		=
CP CP	CONTROL POINT	MIN	MINIMUM	TCE	TEMPORARY CONSTRUCTION EASEMENT
CTB	CEMENT TREATED BASE	MBA	MINIMUM BEARING AREA	TEMP	TEMPORARY
~ 1W	ermonrous to thinker's toucher get think by	MOA	MILLED OVER ALL	TIP	TIP OF SHEET PILE
(D)	DRAIN	мJ	MECHANICAL JOINT	TOE	THREADED ONE END
DCVA	DOUBLE CHECK VALVE ASSEMBLY	мо	MAINTENANCE ORDER	TOP	TOP OF SHEET PILE WALL
DET	DETAIL	MOE	MILLED ONE END	TJ	THIOL NOTYT
DFG	DEPARTMENT OF FISH AND GAME	MT	MALE THREAD	TYP	TYPICAL
DI DI	DUCTILE IRON			TW	TOP OF WALL
		N (N)	NORTHING	UL	UNDERWRITERS LABORATORY, INC.
DIA	DIAMETER	(N)	NOT APPLICABLE	USBR	UNITED STATES BUREAU OF RECLAMATION
DISC	DISCONNECT	N/A NIC	NOT IN CONTRACT	USCG	UNITED STATES COAST GUARD
DWC	DRAWNG			V	VERTICAL
	DEPARTMENT OF WATER RESOURCES	MOM	NOMINAL	VAR	VARIES
DWG DWR	DEPARTMENT OF WATER RESOURCES	MAC			
DWR	DEPARTMENT OF WATER RESOURCES EXISTING	NTS	NOT TO SCALE	VCP	VITRIFIED CLAY PIPE
		oc	ON CENTER		
DWR (E)	EXISTING	00 00	ON CENTER OUTSIDE DIAMETER	w	WATER
DWR (E) E E8RPD	EXISTING ELECTRIC, EASTING	oc	ON CENTER	W WAPA	WATER WESTERN AREA POWER AUTHORITY
DWR (E) E	EXISTING ELECTRIC, EASTING EAST BAY REGIONAL PARKS DISTRICT	00 00	ON CENTER OUTSIDE DIAMETER	W WAPA WSTP	WATER WESTERN AREA POWER AUTHORITY WATERSTOP
DWR (E) E EBRPD EC	EXISTING ELECTRIC, EASTING EAST BAY REGIONAL PARKS DISTRICT END OF CURVE	OC OD OSHA	ON CENTER OUTSIDE DIAMETER OCCUPATIONAL SAFETY AND HEALTH ACT	W WAPA WSTP WM	WATER WESTERN AREA POWER AUTHORITY WATERSTOP WATER METER
DWR (E) E EBRPD EC EF	EXISTING ELECTRIC, EASTING EAST BAY REGIONAL PARKS DISTRICT END OF CURVE EACH FACE	OC OD OSHA PE	ON CENTER OUTSIDE DIAMETER OCCUPATIONAL SAFETY AND HEALTH ACT POLYETHYLENE	W WAPA WSTP WM W/	WATER WESTERN AREA POWER AUTHORITY WATERSTOP WATER METER WITH
DWR (E) E EBRPD EC EF EG	EXISTING ELECTRIC, EASTING EAST BAY REGIONAL PARKS DISTRICT END OF CURVE EACH FACE FOR EXAMPLE, EXISTING GRADE	OC OD OSHA PE PG&E PI	ON CENTER OUTSIDE DIAMETER OCCUPATIONAL SAFETY AND HEALTH ACT POLYETHYLENE PACIFIC GAS AND ELECTRIC POINT OF INTERSECTION	W WAPA WSTP WM	WATER WESTERN AREA POWER AUTHORITY WATERSTOP WATER METER
DWR (E) E EBRPD EC EF EG EL	EXISTING ELECTRIC, EASTING EAST BAY REGIONAL PARKS DISTRICT END OF CURVE EACH FACE FOR EXAMPLE, EXISTING GRADE ELEVATION	OC OD OSHA PE PG&E	ON CENTER OUTSIDE DIAMETER OCCUPATIONAL SAFETY AND HEALTH ACT POLYETHYLENE PACIFIC GAS AND ELECTRIC POINT OF INTERSECTION PROPERTY LINE	W WAPA WSTP WM W/ W/O	WATER WESTERN AREA POWER AUTHORITY WATERSTOP WATER METER WITH WITHOUT
DWR (E) E EBRPD EC EF EG EL ELEV	EXISTING ELECTRIC, EASTING EAST BAY REGIONAL PARKS DISTRICT END OF CURVE EACH FACE FOR EXAMPLE, EXISTING GRADE ELEVATION ELEVATION	OC OD OSHA PE PG&E PI	ON CENTER OUTSIDE DIAMETER OCCUPATIONAL SAFETY AND HEALTH ACT POLYETHYLENE PACIFIC GAS AND ELECTRIC POINT OF INTERSECTION	W WAPA WSTP WM W/ W/O	WATER WESTERN AREA POWER AUTHORITY WATERSTOP WATER METER WITH WITHOUT BY APP. DATE DESIGN BY: M.MAHER
DWR (E) E EBRPD EC EF EG EL ELEV ELL	EXISTING ELECTRIC, EASTING EAST BAY REGIONAL PARKS DISTRICT END OF CURVE EACH FACE FOR EXAMPLE, EXISTING GRADE ELEVATION ELEVATION ELBOW	OC OD OSHA PE PG&E PI	ON CENTER OUTSIDE DIAMETER OCCUPATIONAL SAFETY AND HEALTH ACT POLYETHYLENE PACIFIC GAS AND ELECTRIC POINT OF INTERSECTION PROPERTY LINE	W WAPA WSTP WM W/ W/O	WATER WESTERN AREA POWER AUTHORITY WATERSTOP WATER METER WITH WITHOUT

DATE: 07/13/2009

-LEFT TURN FROM EAST CYPRESS TO ACCESS ROAD NOT ALLOWED LOCKED ACCESS GATE ONE LANE ACCESS ROAD

EAST CYPRESS ROAD SCALE: 1"=200'

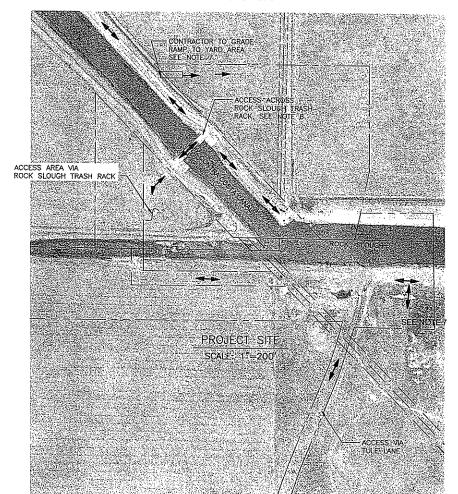

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CONFORMED

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	REV.	DESCRIPTION	ВУ	APP.	DATE	DESIGN BY: M. M.	AHER	Ι
						CHECKED BY: P. BI	TTOMS	
						DRAWN BY: F. BU	JRKE	=
						CHECKED BY: C. JO	YCE	FIS
***************************************						PROJECT NO.: 109065	SCALE: AS SHOWN	00
	. 2	CONFORMED TO INCLUDE ADDENDA	ММ	PB	08/2009	CAL GRID:	ASSESSOR'S BOOK:	1
	1	REVISED PER ADDENDUM 1	CJ	PB1	07-09		ACCESSOR S BOOK	SHEET
DATE: 07/13/2009	0	ISSUED FOR BID		i		CAD FILE:	PLOT DATE:	04


CONTRA COSTA WATER DISTRICT CONCORD, CALIFORNIA

SITE ACCESS DRAWING CONSULTANT REV. D-13028

LINE IS 2 INCHES

AT FULL SIZE

(IF NOT 2"-SCALE ACCORDINGLY)

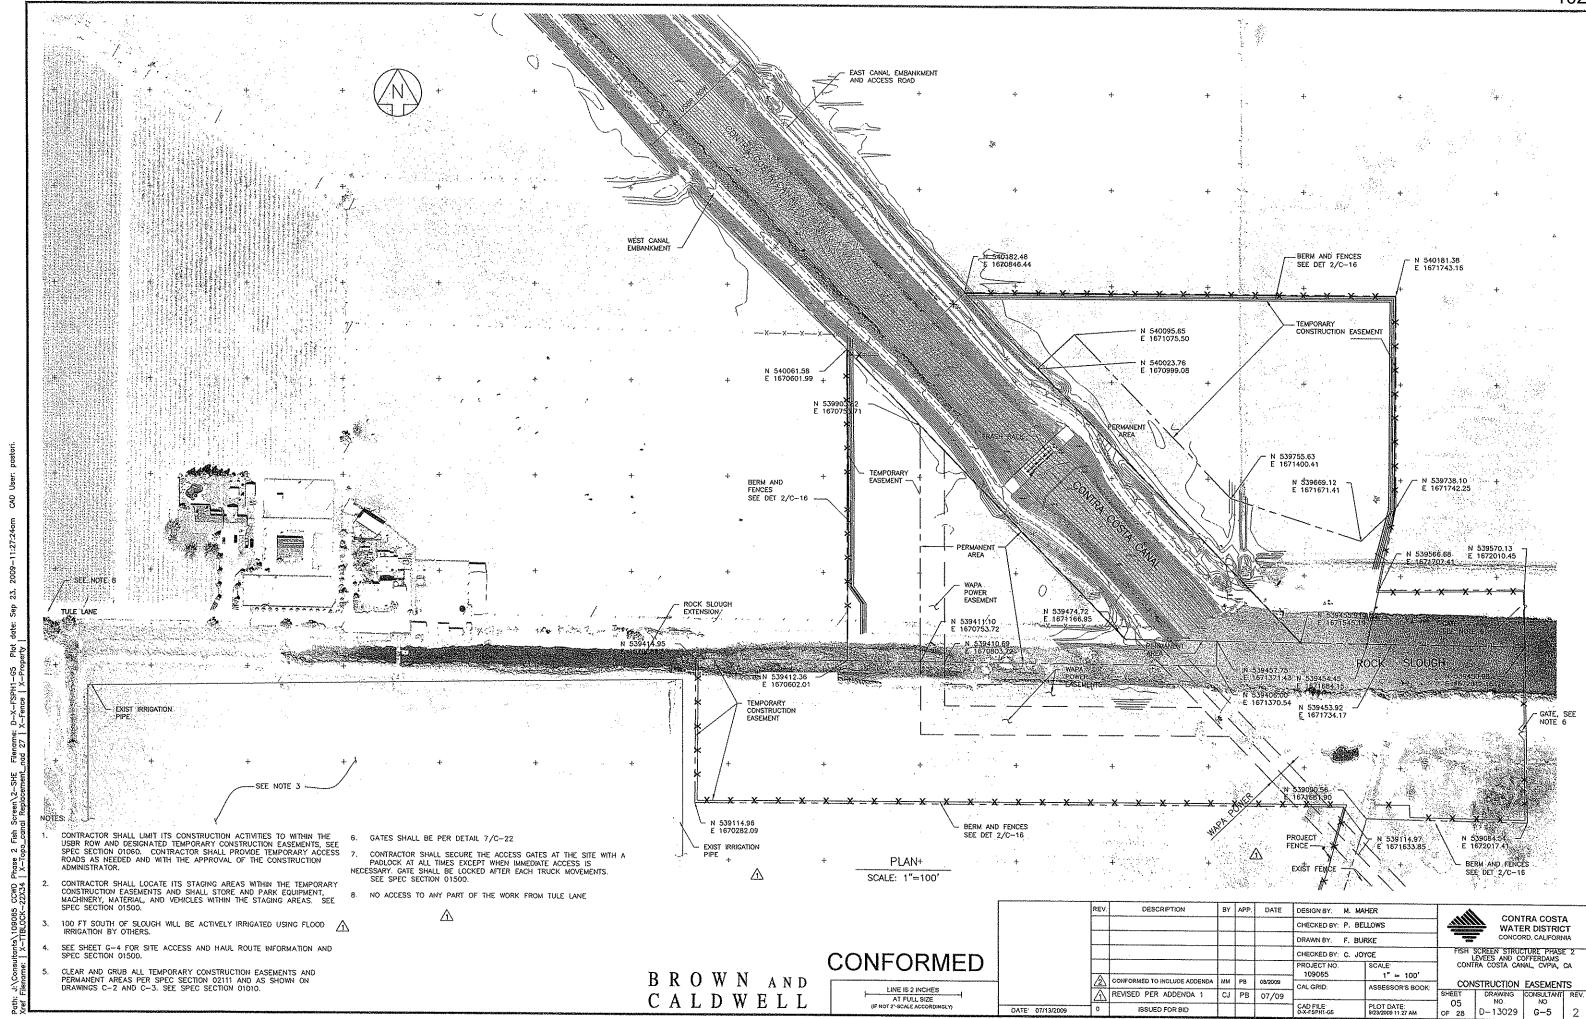

PROJECT NO.: SCALE

ASSESSOR'S BOOK

05A of 28

CONSTRUCTION EASEMENTS


D-13029A

DRAWING CONSULTANT REV.

109065

CAD FILE: D-X-FSPH1-G6

CAL GRID:

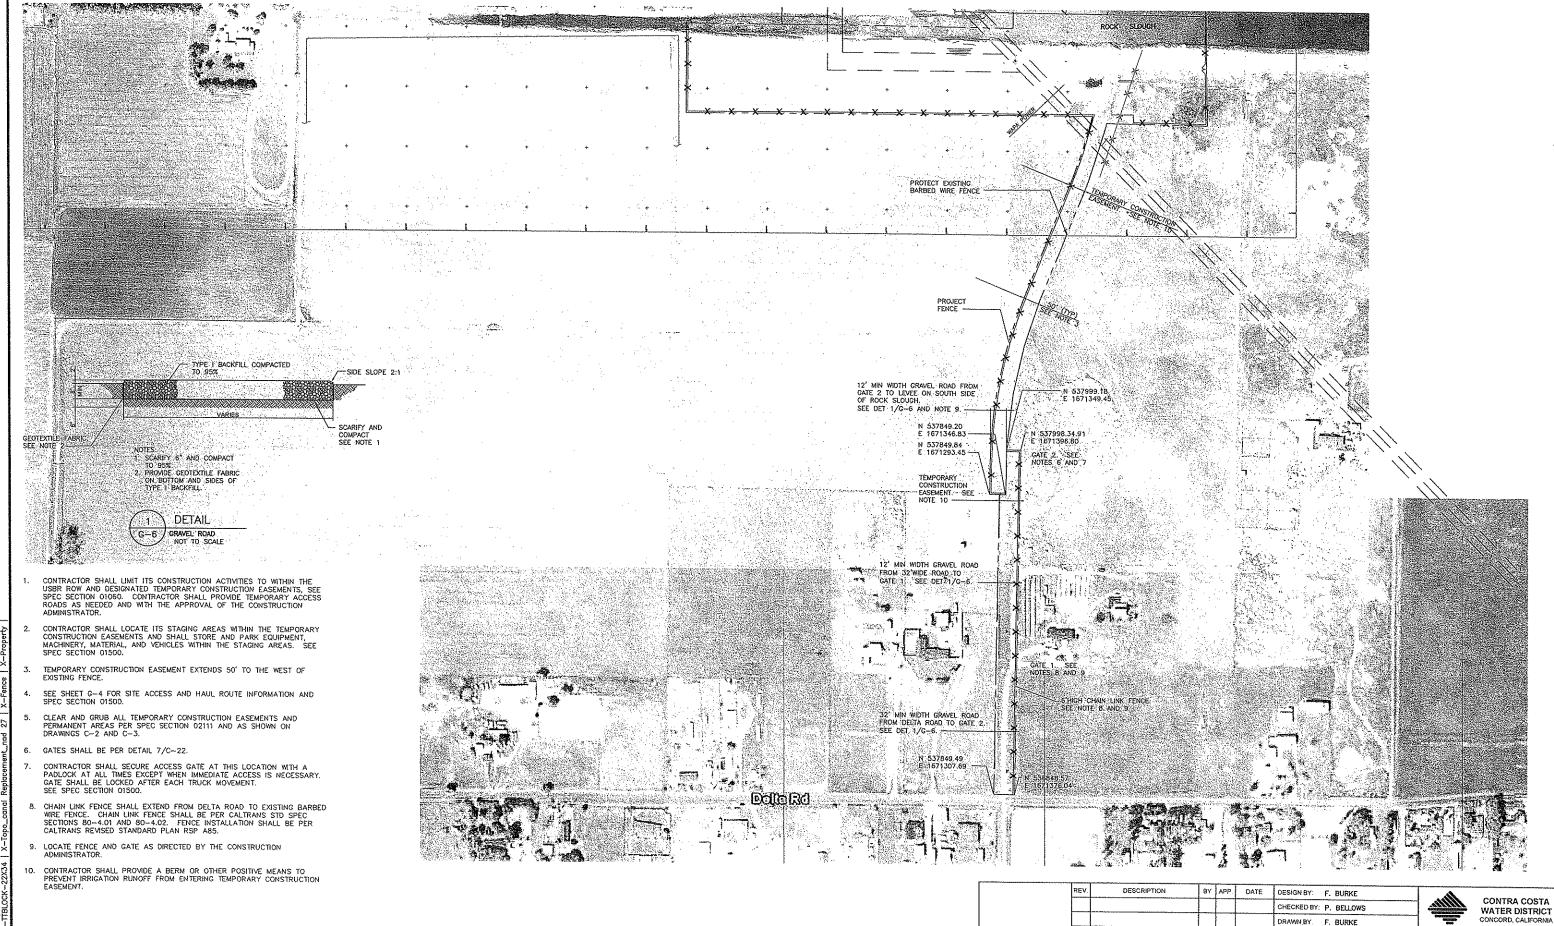

BROWN AND

CALDWELL


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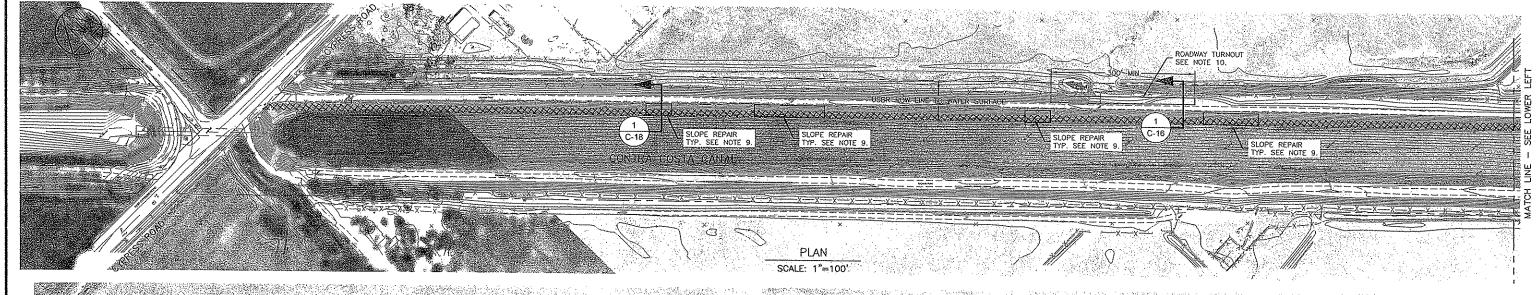
AT FULL SIZE (IF NOT 2"-SCALE ACCORDINGLY)


DATE: 07/13/2009

ISSUED FOR BID

Path: J.)Consultants\199065 CCWD Phase 2 Fish Screen\2-SHE Filename: D-X-FSPHI-G6 Flot date: Sep 23, 2009-11:26:4 yes Filename: | x-TfBI OCX-29X34 | X-fan canal Renlatement and 27 | X-Fence | X-Prosety |



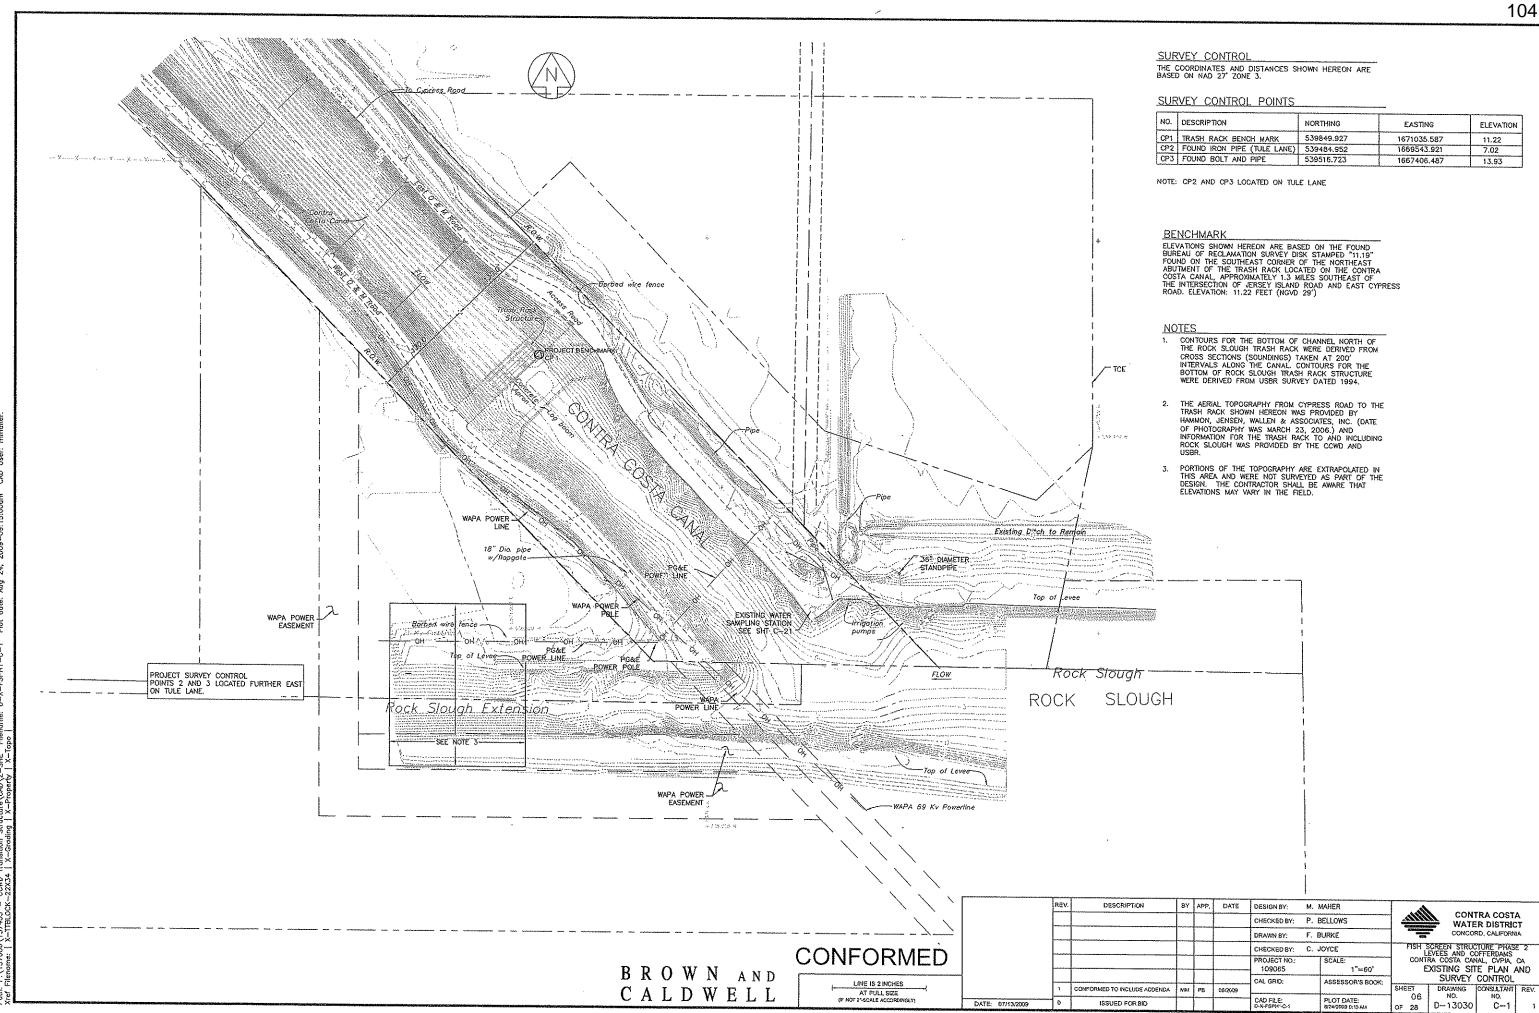

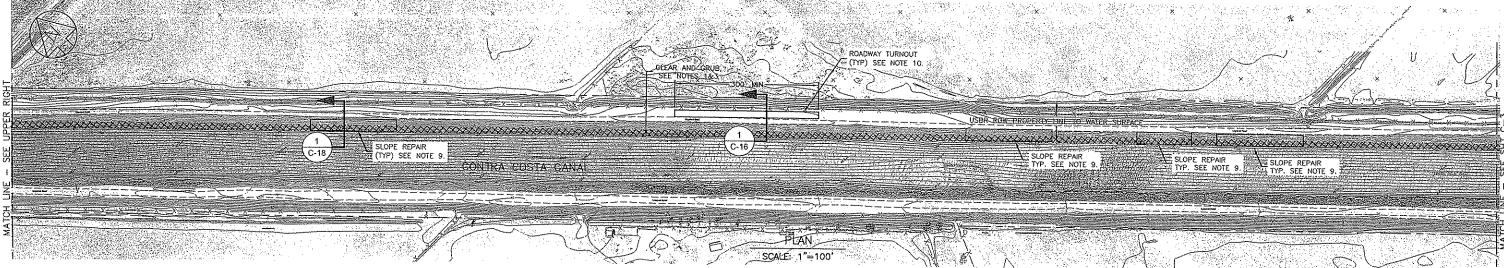

- CLEAR AND GRUB ON WATER SIDE OF CANAL AND ROCK SLOUGH EMBANKMENT WHERE NEEDED FOR EMBANKMENT REPAIRS IN AREAS WITHIN THE TCA IN ACCORDANCE WITH SECTION 02111, SEE NOTE 1 AND 9.
- CONTRACTOR SHALL ALLOW VEHICULAR TRAFFIC ALONG ACCESS ROAD FOR CCWD. RD799 AND USBR STAFF.
- 3. NOT USED
- 4. NOT USED.
- MAINTAIN SECURITY OF CANAL AND WORK AREA AT ALL TIMES DURING CONSTRUCTION. KEEP GATES LOCKED BEFORE AND AFTER EACH TRUCK OR VEHICLE MOVEMENT TO MAINTAIN SITE SECURITY AND TO ENSURE NO LIVESTOCK CAN ENTER THE WORK AREA AND ESCAPE. NO REMOVAL OR TEMPORARY RELOCATION OF USBR FENCE UNLESS IT IS APPROVED BY CONSTRUCTION ADMINISTRATOR.
- 6. SEE SHEETS G-1 AND G-4 FOR ACCESS AND HAUL ROUTES.
- 7. CONTRACTOR SHALL CLEAR AND GRUB TO LIMITS SHOWN ON SHEET C-2 AND C-3.
- B. CONTRACTOR SHALL REPAIR AND WIDEN ACCESS ROADS AS NEEDED WITHIN EXISTING R-O-W WHILE PROTECTING DESIGNATED WETLAND AREAS TO PROVIDE ACCESS TO AND FROM WORK SITE.
- AREAS DESIGNATED AS SLOPE REPAIR ARE FOR BID PURPOSES ONLY AND CONTRACTOR SHALL ASSUME 3,000 FT OF CANAL OR SLOUGH EMBANKMENT SLOPE REPAIR AT MULTIPLE LOCATIONS. CONTRACTOR SHALL INVESTIGATE EXISTING CANAL EMBANKMENT PRIOR TO ROAD REPAIR TO ROAD REPAIR WORK AND REMOVAL OF RIPPAP ALONG SLOUGH AND COMPLETE ALL NECESSARY SLOPE REPAIRS PER DETAIL 1/C-18 IN ORDER TO PREVENT EMBANKMENT FALURE DURING THE PROJECT. CONTRACTOR SHALL PERFORM EMBANKMENT REPAIRS AS DIRECTED BY THE CONSTRUCTION ADMINISTRATOR AND AS SPECIFIED IN SPEC SECTION 01500.
- 10. CONTRACTOR SHALL WIDEN EXISTING CANAL ACCESS ROAD TO PROVIDE THREE (3) 300-FOOT LONG TURNOUTS FOR CONSTRUCTION VEHICLES BETWEEN CYPRESS ROAD AND THE ROCK SOUGH TRASH RACK. CONTRACTOR MAY LENGTHEN EXISTING TURNOUTS TO 300 FEET PER DETAIL 1/C-16. TURNOUT SHALL BE WIDE ENDUGH TO ACCOMMODATE TWO WAY TRAFFIC FOR CONSTRUCTION VEHICLES. WIDEN EXISTING ROADWAY PER DETAIL 1/C-16. ROADWAY WIDENING SHALL NOT EXTEND INTO EXISTING WETLAND AREAS SHOWN ON SHEET C-4.

CONFORMED

DESCRIPTION DATE DESIGN BY: M. MAHER CONTRA COSTA CHECKED BY: P. BELLOWS WATER DISTRICT CONCORD, CALIFORNIA DRAWN BY. F. BURKE FISH SCREEN STRUCTURE PHASE 2 LEVEES AND COFFERDAMS CONTRA COSTA CANAL, CVPIA, CA CHECKED BY: C. JOYCE PROJECT NO. 109065 CLEAR AND GRUB LIMITS - DEMO-ACCESS ROAD REPAIR (1 OF 2)
SHEET DRAWING CONSULTANT REV
07 NO. NO. ASSESSOR'S BOOK CAL GRID CONFORMED TO INCLUDE ADDENDA CAD FILE D-X-FSPHI-C2 PLOT DATE: 9/23/2009 11:17 A DATE: 07/13/2009 ISSUED FOR BID D-13031

AT FULL SIZE (IF NOT 2"-SCALE ACCORDINGLY)

CAL GRID

CAD FILE 0-X-FSPHI-C3

07-09

REVISED PER ADDENOUM 1

DATE 07/13/2009


ASSESSOR'S BOOK

PLOT DATE: 9/23/2009 11 20 AN

08

DRAWING CONSULTANT REV

D-13032

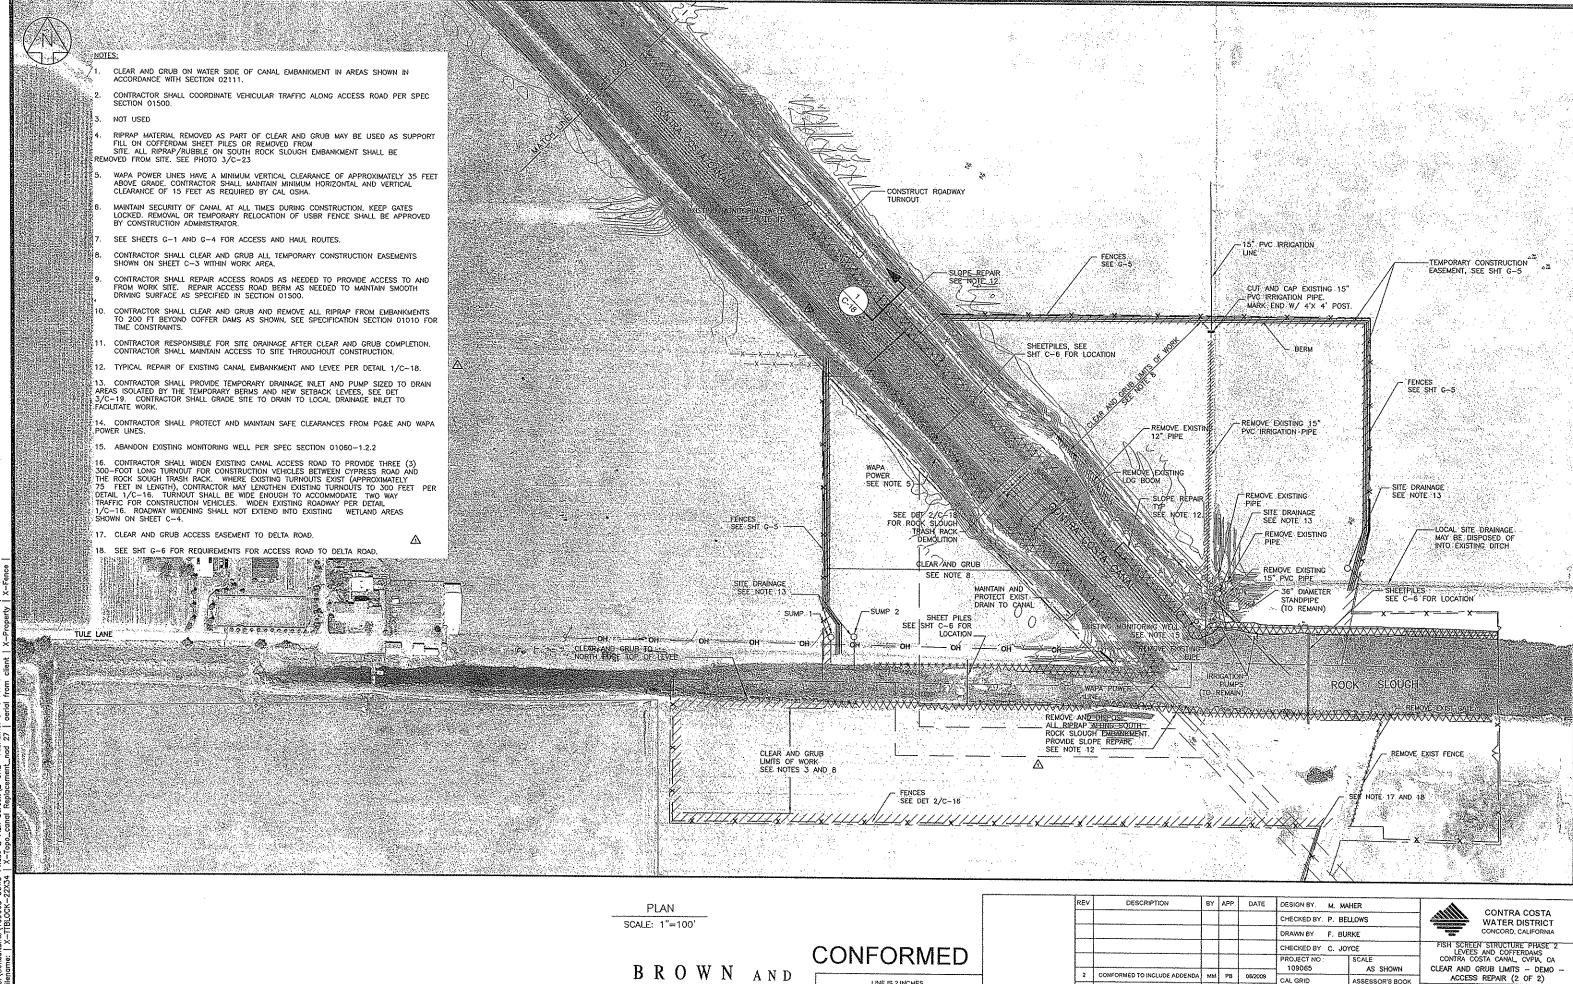

CALDWELL

LINE IS 2 INCHES

- 1. SEE SPEC SECTION 01010 FOR TIME CONSTRAINTS.
- 2. SEE SPEC SECTION 01060 FOR ENVIRONMENTAL CONSTRAINTS.

CONFORMED


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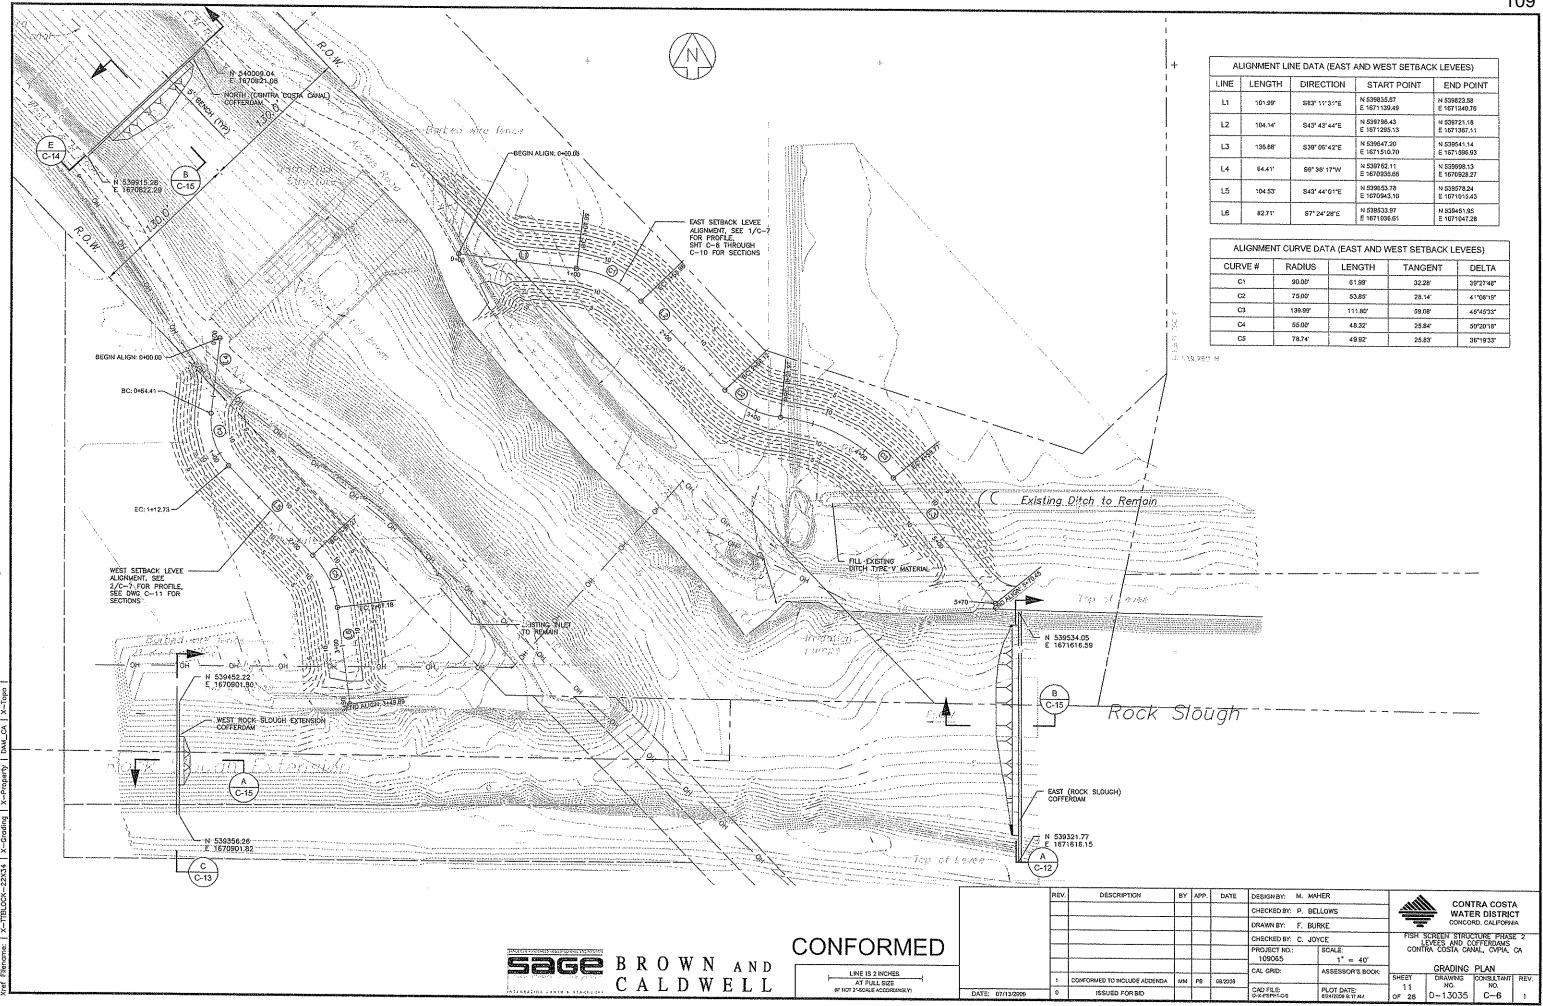
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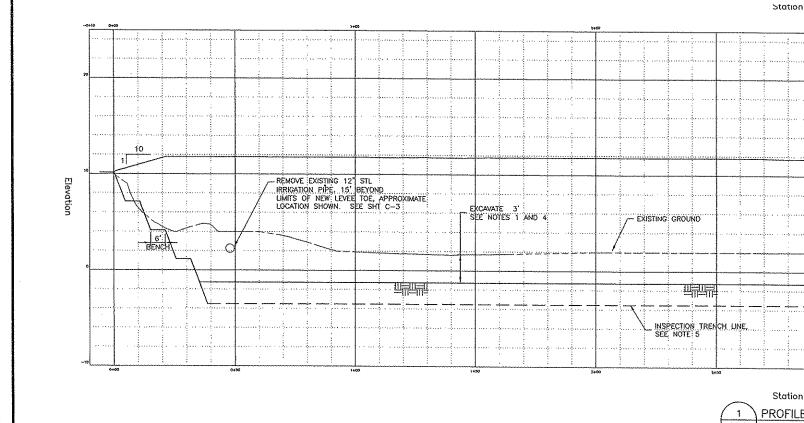
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		~~~				PROJECT NO 109065	SCALE: AS SHOWN	CON
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CONTRA COSTA WATER DISTRICT CONCORD, CALIFORNIA







Station

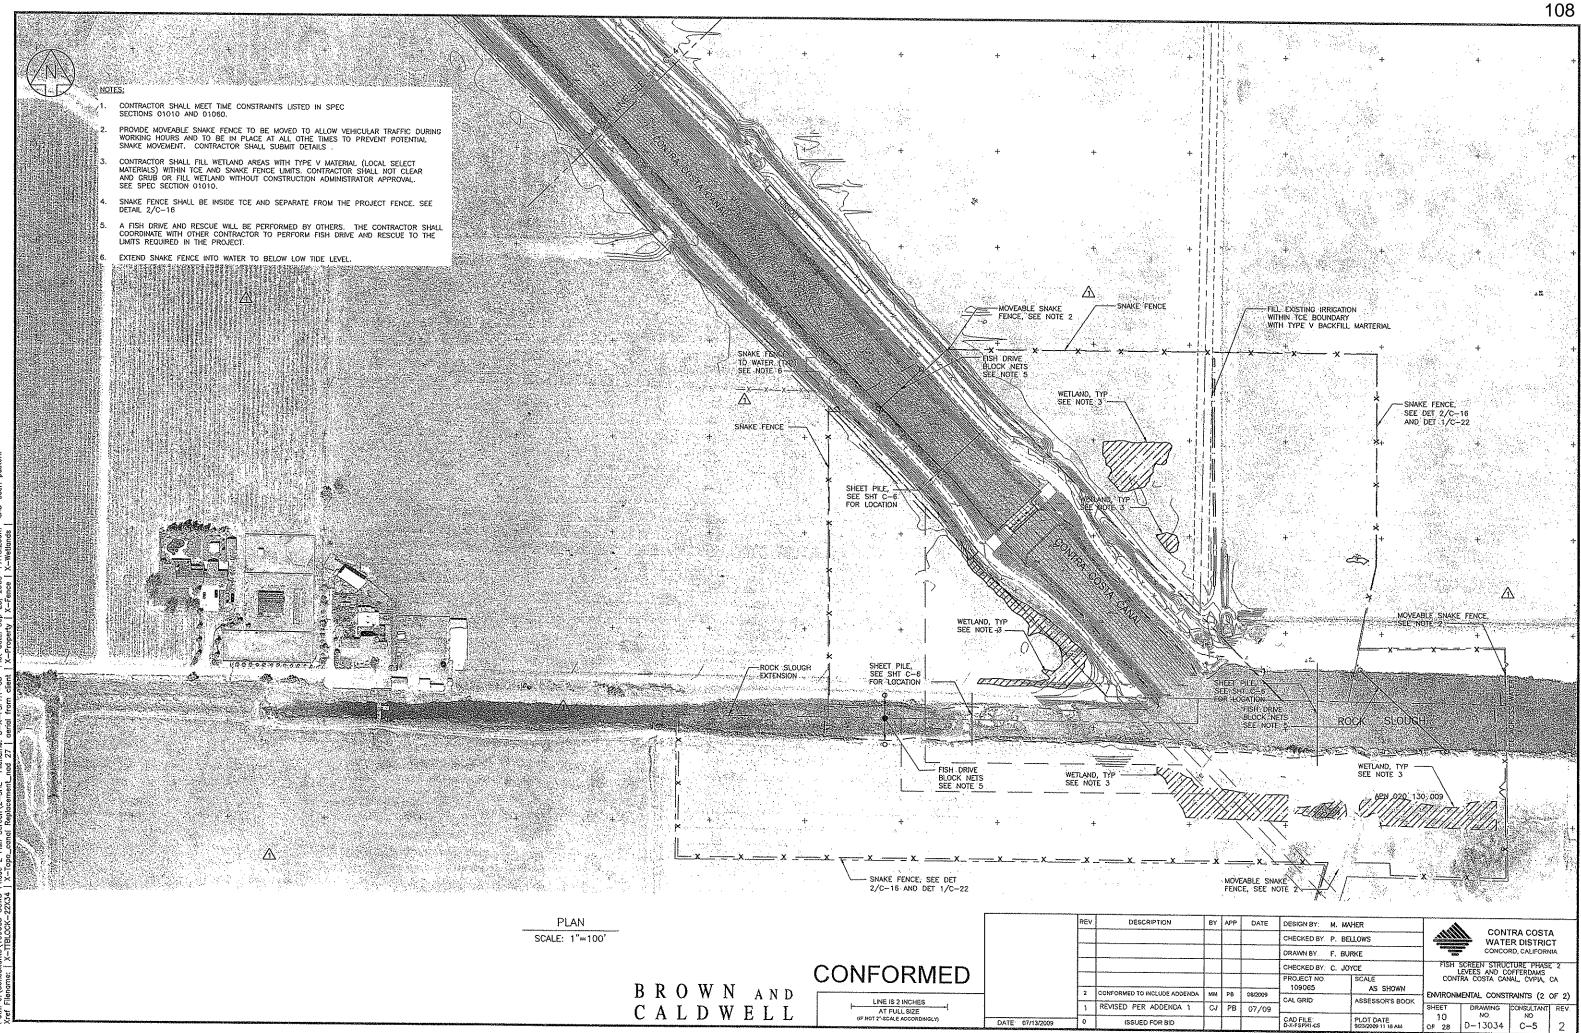PROFILE - EAST SETBACK LEVEE


SCALE 1" = 20' H
1" = 5' V

FINISHED SURPACE ... EAST SET BACK LEVEE CENTERLINE EL 11.60

RÉMOVE EXISTING 15" PVC IRRIGATION

PIPE 15' BEYOND LIMITS OF NEW LEVEE TOE. APPROXIMATE LOCATION SHOWN, SEE SHEET C-3.

EXCAVATE 3' MIN

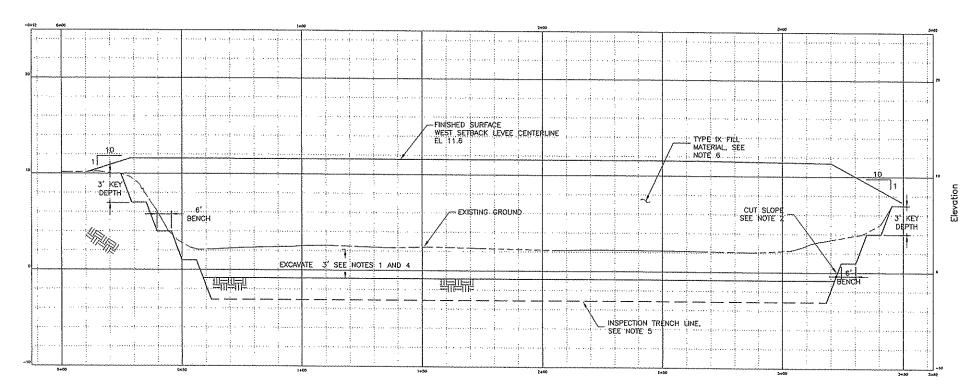

#### NOTES:

TYPE IX FILL MATERIAL, SEE NOTE 6


 REMOVE AND STOCKPILE TOP 18" OF MATERIAL IF REQUIRED BY TCE, REMOVE AND DISPOSE REMAINING 18" OF MATERIAL.

DEBIH. 3, KEA.

BENCH BENCH

> CUT SLOPE SEE NOTE 2

- SIDE SLOPE SHALL BE DETERMINED BY CONTRACTOR IN ACCORDANCE WITH CAL-OSHA REQUIREMENTS. SLOPE SHALL NOT EXCEED 1.5:1.
- COMPACT FILL MATERIAL TO 95% RELATIVE COMPACTION, SEE SPEC SECTION 02220.
- 4. CONTRACTOR SHALL EXCAVATE 3' BELOW EXISTING GROUND (DEPTH PRIOR TO CLEAR AND GRUBBING). PRIOR TO SCARIFICATION, BASE OF EXCAVATION SHALL BE OBSERVED BY LEVE DESIGN ENGINER. UPON APPROVAL OF SUBGRADE BY LEVEE DESIGN ENGINEER, CONTRACTOR SHALL PREPARE AND LEVEL LEVEE FOUNDATION PRIOR TO CONSTRUCTION OF LEVEES AND PLACEMENT OF BACKFILL MATERIAL. SEE SPEC SECTION 02220 FOR FURTHER DETAIL.
- 5. SEE LEVEE CROSS SECTIONS SHEET FOR INSPECTION TRENCH GEOMETRY.
- 6. SEE SPEC SECTION 02220 FOR LIME TREATMENT REQUIREMENTS.

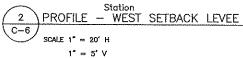



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						DRAWN BY:	F. BURKE		1
						CHECKED BY:	C. JOYCE	***************************************	T
	<u> </u>					PROJECT NO.: 109065	SCALE:	1"=20'(H) 1"=4'(V)	] E
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	<u>                                     </u>	CONFORMED TO INCLUDE ACCEMBA	MM	PB	08/2009	***************************************			1
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PROFILE

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12 NO. NO.
OF 28 D-13036 C-7 1


:\Consultants\109065 CCWD Phase 2 Fish Screen\2-


1" = 5' V


SARRIES & ASSOCIATE SEOSTROCHUS


LINE IS 2 INCHES

AT FULL SIZE
(IF NOT 2"-SCALE ACCORDINGLY)

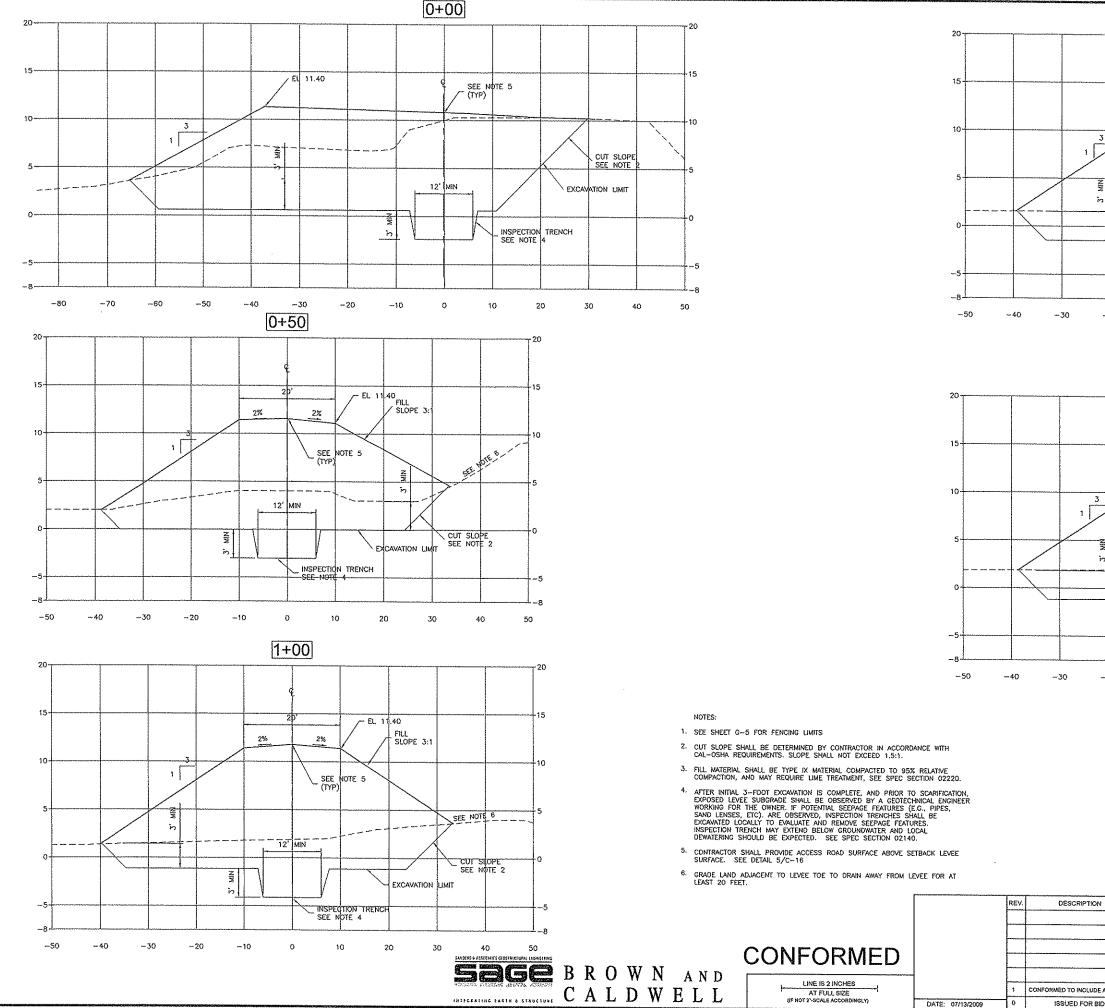

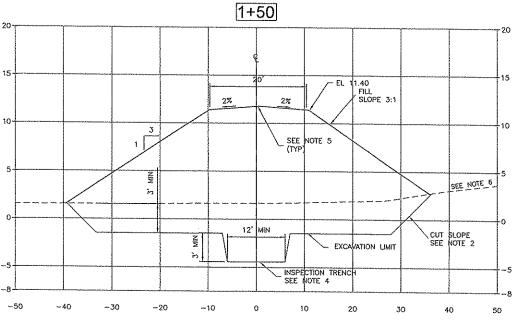


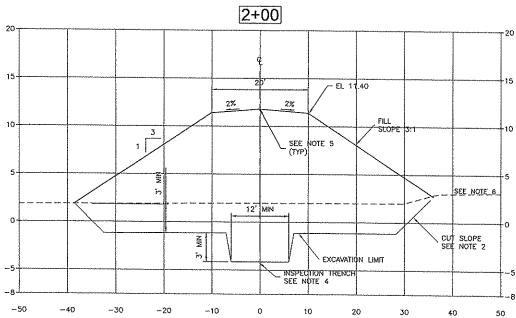


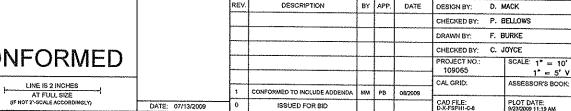


CONTRA COSTA WATER DISTRICT CONCORD, CALIFORNIA FISH SCREEN STRUCTURE PHASE 2 LEVEES AND COFFERDAMS CONTRA COSTA CANAL, CVPIA, CA

1" == 5' V EAST LEVEE SECTIONS (1 OF 3) SHEET DRAWING CONSULTANT REV. NO. NO. OF 28 D-13037 C-8 1 OF 28 D-13037

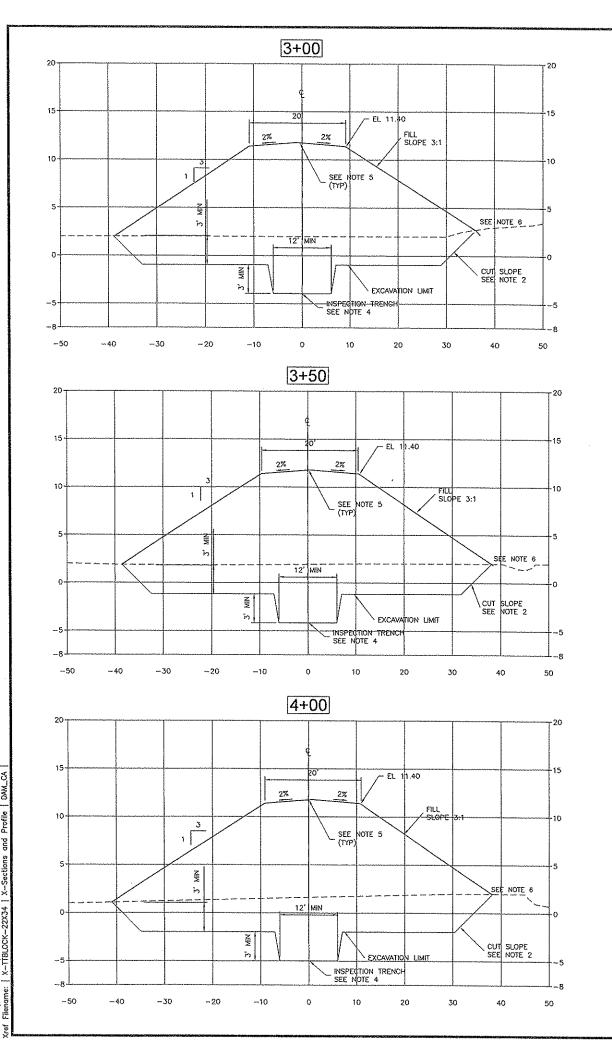

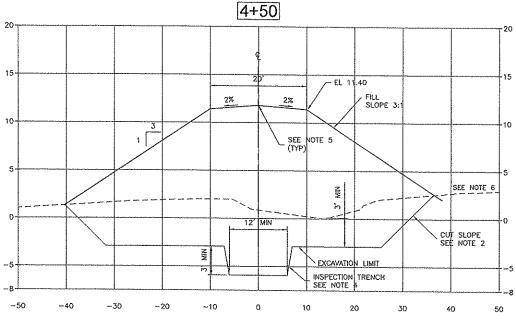

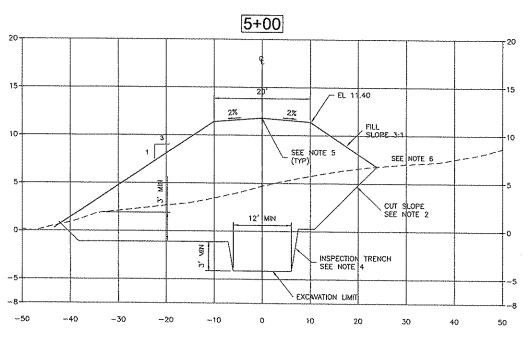

NOTES:

- 1. SEE SHEET G-5 FOR FENCING LIMITS
- CUT SLOPE SHALL BE DETERMINED BY CONTRACTOR IN ACCORDANCE WITH CAL-OSHA REQUIREMENTS. SLOPE SHALL NOT EXCEED 1.5:1.
- FILL MATERIAL SHALL BE TYPE IX MATERIAL COMPACTED TO 95% RELATIVE COMPACTION, AND MAY REQUIRE LIME TREATMENT, SEE SPEC SECTION 02220.
- 4. AFTER INITIAL 3-FOOT EXCAVATION IS COMPLETE, AND PRIOR TO SCARIFICATION, EXPOSED LEVEE SUBGRADE SHALL BE OBSERVED BY A GEOTECHNICAL ENGINEER WORKING FOR THE OWNER. IF POTENTIAL SEEPAGE FEATURES (E.G., PIPES, SAND LENSES, ETC). ARE OBSERVED, INSPECTION TRENCHES SHALL BE EXCAVATED LOCALLY TO EVALUATE AND REMOVE SEEPAGE FEATURES. INSPECTION TRENCH MAY EXPERD BELOW GROUNDWARTER AND LOCAL DEWATERING SHOULD BE EXPECTED. SEE SPEC SECTION 02140.
- CONTRACTOR SHALL PROVIDE ACCESS ROAD SURFACE ABOVE SETBACK LEVEE SURFACE. SEE DETAIL 5/C-16
- Grade Land adjacent to levee toe to drain away from levee for at least 20 feet.



BROWN AND CALDWELL

### CONFORMED


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LINE IS 2 INCHES
AT FULL SIZE
(IF NOT 2"-SCALE ACCORDINGLY)

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							CHECKED BY:	C.	JOYCE	FIS
							PROJECT NO.: 109065		SCALE:1" = 10'	
		ļ					CAL GRID:		ASSESSOR'S BOOK:	EAST
		L,	CONFORMED TO INCLUDE ADDENDA	MM	PB	08/2009				SHEET
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FISH SCREEN STRUCTURE PHASE 2 LEVEES AND COFFERDAMS CONTRA COSTA CANAL, CVPIA, CA

| EAST LEVEE SECTIONS (2 OF 3) | SHEET | DRAWING | CONSULTANT | REV. | NO. | N



NOTES:

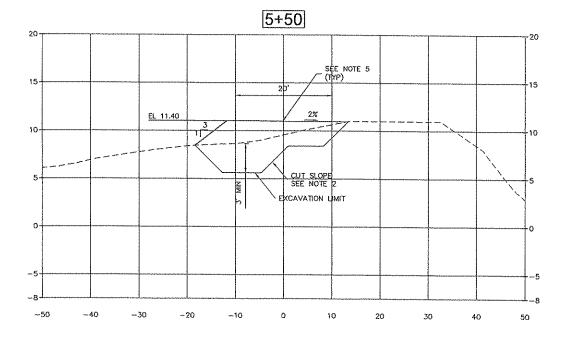- 1. SEE SHEET G-5 FOR FENCING LIMITS
- CUT SLOPE SHALL BE DETERMINED BY CONTRACTOR IN ACCORDANCE WITH CAL-OSHA REQUIREMENTS. SLOPE SHALL NOT EXCEED 1.5:1.
- FILL MATERIAL SHALL BE TYPE IX MATERIAL COMPACTED TO 95% RELATIVE COMPACTION, AND MAY REQUIRE LIME TREATMENT, SEE SPEC SECTION 02220.
- 4. AFTER INITIAL 3-FOOT EXCAVATION IS COMPLETE, AND PRIOR TO SCARIFICATION, EXPOSED LEVEE SUBGRADE SHALL BE OBSERVED BY A GEOTECHNICAL ENGINEER WORKING FOR THE OWNER, IF POTENTIAL SEEPAGE FEATURES (E.G., PIPES, SAND LENSES, ETC.) ARE OBSERVED, INSPECTION TRENCHES SHALL BE EXCAVATED LOCALLY TO EVALUATE AND REMOVE SEEPAGE FEATURES. INSPECTION TRENCH MAY EXTEND BELOW GROUNDWATER AND LOCAL DEWATERING SHOULD BE EXPECTED. SEE SPEC SECTION 02140.
- $^{5.}$  Contractor shall provide access road surface above setback levee surface. See detail  $5/\text{C}{-}16$
- GRADE LAND ADJACENT TO LEVEE TOE TO DRAIN AWAY FROM LEVEE FOR AT LEAST 20 FEET.

ANDRES A ASSOCIATE CHOST PROCEDURAL INCOMPLEXAND

B R O W N AND

C A L D W E L L

CONFORMED

LINE IS 2 INCHES

AT FULL SIZE
(IF NOT 2"-SCALE ACCORDINGLY)

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						PROJECT NO.: 109065		SCALE 1" = 10' 1" = 5' V	١,,,
	_			ļ		CAL GRID:		ASSESSOR'S BOOK:	EAS
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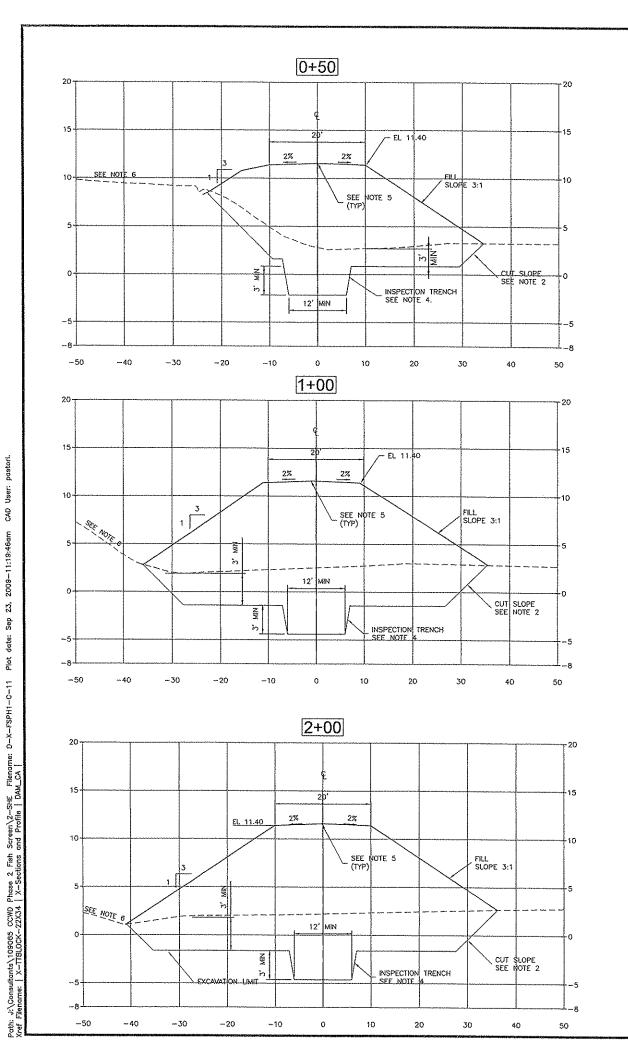
CONTRA COSTA WATER DISTRICT CONCORD, CALIFORNIA


FISH SCREEN STRUCTURE PHASE 2 LEVEES AND COFFERDAMS CONTRA COSTA CANAL, CVPIA, CA

EAST LEVEE SECTIONS (3 OF 3)

SHEET DRAWING CONSULTANT REV.

15 NO. NO.
OF 28 D-13039 C-10 1



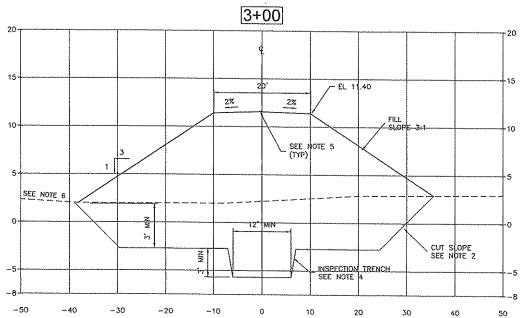

NOTES:

- 1. SEE SHEET G-5 FOR FENCING LIMITS
- CUT SLOPE SHALL BE DETERMINED BY CONTRACTOR IN ACCORDANCE WITH CAL-OSHA REQUIREMENTS. SLOPE SHALL NOT EXCEED 1.5:1.
- FILL MATERIAL SHALL BE TYPE IX MATERIAL COMPACTED TO 95% RELATIVE COMPACTION, AND MAY REQUIRE LIME TREATMENT, SEE SPEC SECTION 02220.
- 4. AFTER INITIAL 3—FOOT EXCAVATION IS COMPLETE, AND PRIOR TO SCARIFICATION, EXPOSED LEVEE SUBGRADE SHALL BE OBSERVED BY A GEOTECHNICAL ENGINEER WORKING FOR THE OWNER. IF POTENTIAL SEEPAGE FEATURES (E.G., PIPES, SAND LENSES, ETC). ARE OBSERVED, INSPECTION TRENCHES SHALL BE EXCAVATED LOCALLY TO EVALUATE AND REMOVE SEEPAGE FEATURES. INSPECTION TRENCH MAY EXTEND BELOW GROUNDWATER AND LOCAL DEWATERING SHOULD BE EXPECTED. SEE SPEC SECTION 02140.
- 5. CONTRACTOR SHALL PROVIDE ACCESS ROAD SURFACE ABOVE SETBACK LEVEE SURFACE. SEE DETAIL 5/C-16
- GRADE LAND ADJACENT TO LEVEE TOE TO DRAIN AWAY FROM LEVEE FOR AT LEAST 20 FEET.




CONFORMED LINE IS 2 INCHES.

		REV.	DESCRIPTION	BY	APP.	DATE	DESIGN BY:	D.	MACK	- 40
							CHECKED BY:	Ρ.	BELLOWS	
							DRAWN BY:	F.	BURKE	
							CHECKED BY:	C.	JOYCE	FISH
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CONTRA COSTA
WA TER DISTRICT
CONCORD, CALIFORNIA
FISH SCREEN STRUCTURE PHASE 2
LEVEES AND COFFERDAMS
CONTRA COSTA CANAL, CYPIA, CA

WEST LEVEE SECTIONS (1 OF 1)
SHEET | DRAWING | CONSULTANT | REV.

D-13040

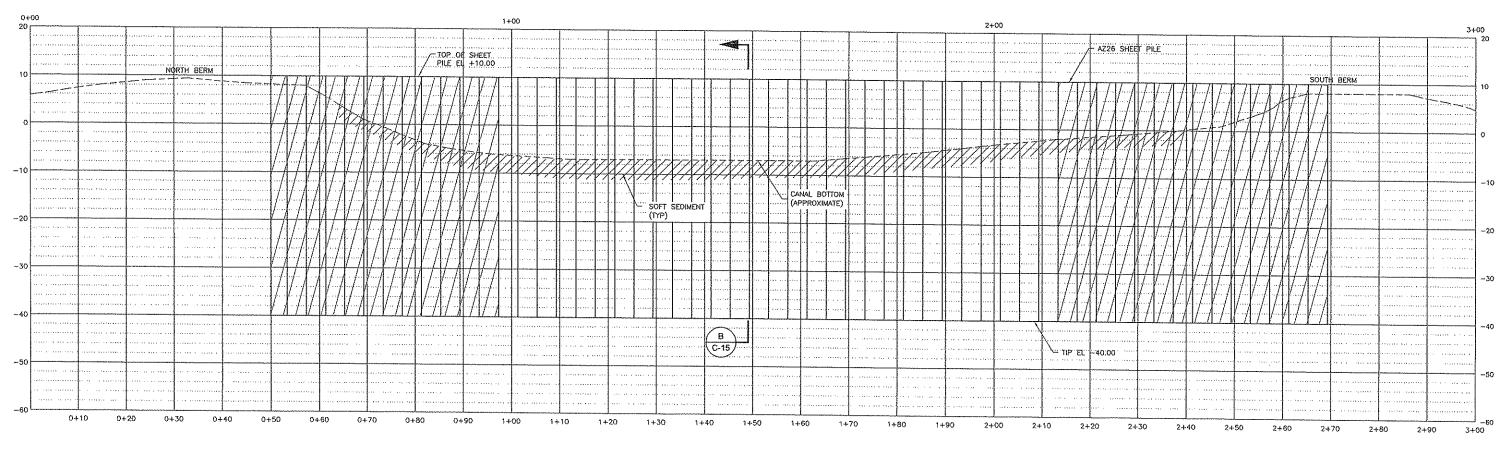

C-6


EAST (ROCK SLOUGH) COFFERDAM SECTION SCALE 1" = 10' H 1" = 10' V

#### NOTES:

COFFERDAM SYSTEM DESIGN ASSUMES EAST COFFERDAM CLOSURE WITH WATER SURFACE AT EL +3 FT OR LOWER. SEE SPEC SECTION 02670 FOR PHASING REQUIREMENTS.



DENOTES SHEET PILES TO BE CUT OFF AT MUD LINE AT COMPLETION OF PHASE 3 CONSTRUCTION (N.I.C.) THESE PILES SHALL NOT BE EXTRACTED

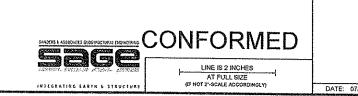

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						CHECKED BY: D.	MACK	FISH SCREEN STRUCTURE PHA LEVEES AND COFFERDAMS			
	ļ					PROJECT NO.: 109065	SCALE: AS SHOWN	CONT EA	ra costa can IST (ROCK	ML, CVPM, SLOUGH)	CA
						CAL GRID:	ASSESSOR'S BOOK:	C	OFFERDAM	SECTION	
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0+00

WEST (ROCK SLOUGH EXTENSION) COFFERDAM c) C-6 SECTION

SCALE 1" = 10' H

1" = 10' V

NOTES:

COFFERDAM DESIGN ASSUMES WATER SURFACE ELEVATION IS CONSTANT AT EL +3 FT OR LOWER BY THE COMPLETION OF THE EAST (ROCK SLOUGH) COFFERDAM. OTHER PHASING RESTRICTIONS APPLY. SEE SPEC SECTION 02670.

DENOTES SHEET PILES TO BE CUT OFF AT MUD LINE AT COMPLETION OF PHASE 3 CONSTRUCTION (N.I.C.) THESE PILES SHALL NOT BE EXTRACTED.


SAMBLER & ASSOCIATES CHOSTRUCTURAL ENGOACEMENT CONFORMED **586** LINE IS 2 INCHES


AT FULL SIZE

(IF NOT 2"-SCALE ACCORDINGLY) INTEGRATING TARTH & STRUCTURE

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						PROJECT NO.: 109065	SCALE: AS SHOWN	CONT	RA COSTA CAN	VAL, CVPIA, I	CA SION
						CAL GRID:	ASSESSOR'S BOOK:	c	OFFERDAM	SECTION	
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E C-6

### NORTH (CONTRA COSTA CANAL) COFFERDAM

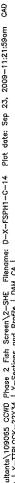SECTION SCALE 1" = 10' H 1" = 10' V

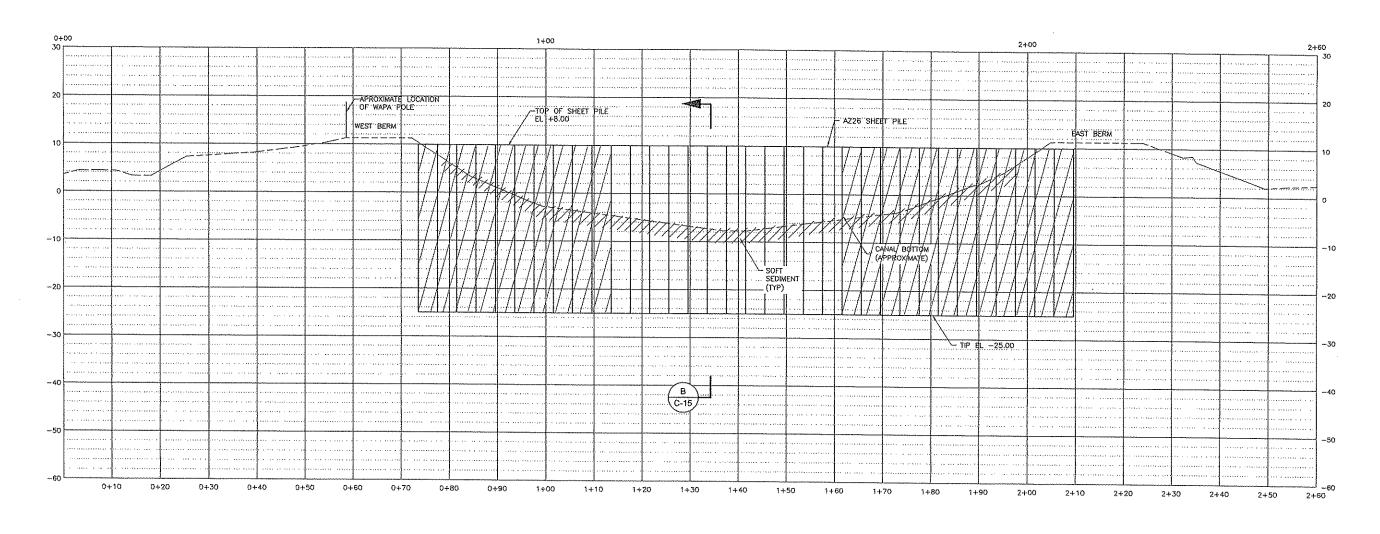
### NOTES:


1. COFFERDAM DESIGN ASSUMES WATER SURFACE ELEVATION IS CONSTANT AT EL +3 FT OR LOWER BY THE COMPLETION OF THE EAST (ROCK SLOUGH) COFFERDAM. OTHER PHASING RESTRICTIONS APPLY. SEE SPEC SECTION 02670.

DENOTES SHEET PILES TO BE CUT OFF AT MUD LINE AT COMPLETION OF PHASE 3 CONSTRUCTION (N.I.C.) THESE PILES SHALL NOT BE EXTRACTED.




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					1	CHECKED BY: D.	MACK	FISH SCR	REEN STRUC EES AND CO	TURE PHASE	ž 2
	$\vdash \vdash$		<u> </u>			PROJECT NO.: 109065	SCALE: 1" = 10' H 1" = 10' V	ONTRA NORTH (	COSTA CAN CONTRA C	VAL, CVPIA, ( COSTA CAN	CA NAL)
	$\vdash$	<u> </u>	<b></b> '		·'	CAL GRID:	ASSESSOR'S BOOK:		FERDAM S	SECTION	
	111	CONFORMED TO INCLUDE ADDENDA	мм	PB	08/2009				DRAWING NO.	CONSULTANT	REV.
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B EAST AND NORTH COFFERDAM - SECTION

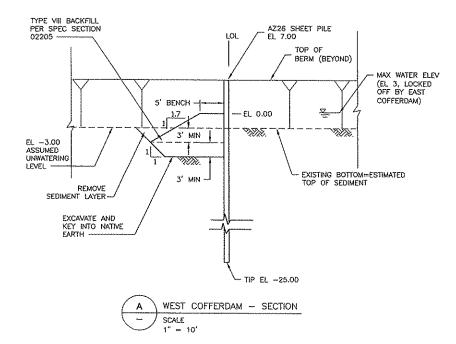SCALE
1" = 10'

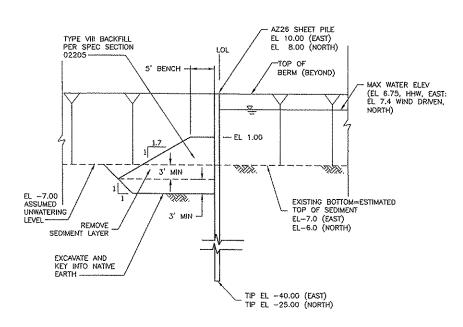

1 <u>COFFERDAM NOTES:</u>


1.1 If is the contractor's responsibility to identify and avoid existing utilities within the construction area. See sheet 6-3.

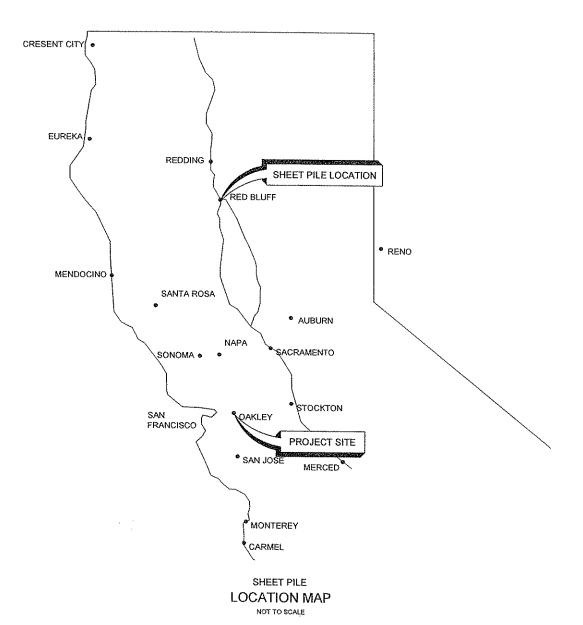
ACTIVE AND

- 1.2 CONTRACTOR SHALL PROVIDE EQUIPMENT AND PERSONNEL ADEQUATE FOR COMPLETING WORK WITHIN SCHEDULE.
- 1.3 REMOVE (E) RIPRAP AS INDICATED. SEE SPEC SECTION 02670.
- 2 DESIGN NOTES:
- 2.1 DESIGN ULTIMATE SOIL PARAMETERS:

MATERIAL	ACTIVE PRESSURE (NON-SUBMERGED)	HYDROSTATIC PRESSURE (SUBMERGED)	PASSIVE PRESSURE (SUBMERGED)
SEDIMENT	N/A	82 PCF	0
CANAL SUBGRADE	30 PCF	82 PCF	180 PCF
CANAL BERM	51 PCF	86 PCF	180 PCF
ROCK FILL	20 PCF	74 PCF	160 PCF (SLOPING)


- 3 <u>CONSTRUCTION NOTES:</u>
- 3.1 SEE SPEC SECTION 02670 FOR COFFERDAM SPECIFICATIONS.
- PRIOR TO CONSTRUCTION, THE CONTRACTOR SHALL SUBMIT A WORK PLAN DEPICTING PROPOSED COFFERDAM INSTALLATION METHODOLOGY, SEQUENCING, AND EQUIPMENT. SEE SPEC SECTIONS 01010, 02351, AND 02670.
- 3.3 DENSE SANDY SOILS MAY EXIST BELOW ELEVATION -16 FEET. THE CONTRACTOR SHOULD ANTICIPATE JETTING OR PREDRILLING SHEET PILES WHERE DIFFICULT PILE DRIVING OCCURS. SEE SPEC SECTION 02351 AND APPENDIX A (GEOTECHNICAL DATA REPORT) FOR MORE INFORMATION.
- 3.4 SEE SPEC SECTIONS 02351 AND 05100 FOR COFFERDAM SHEET PILE REQUIREMENTS.
  SHEET PILES SHALL HAVE A SECTION MODULUS OF AT LEAST 48.4 IN /FT. AZ26
  SHEET PILES WILL BE PROVIDED BY USBR (SEE SPEC SECTION 01010).
- 3.5 STRUCTURAL STEEL ELEMENTS SHALL BE DELIVERED AND MAINTAINED IN GOOD WORKING CONDITION, AND SHALL BE FREE OF DAMAGE, DEFORMATION, OR DEGRADATION DUE TO IMPACT, HEAT, CORROSION, AND ALL OTHER CHEMICAL OR PHYSICAL ATTACK. SEE SPEC SECTION 05100 FOR OTHER REQUIREMENTS.
- 3.6 ALL FABRICATION SHALL COMPLY WITH THE CURRENT AISC "MANUAL OF STEEL CONSTRUCTION."
- 3.7 NOT USED.
- 3.8 CONTRACTOR SHALL SURVEY TOPS OF INSTALLED SHEET PILES TO CONFIRM TOP AND TIP ELEVATIONS AND SHALL SUBMIT REPORT TO CONSTRUCTION ADMINISTRATOR PER SPEC SECTION 02351.
- 3.9 SHEET PILE INTERLOCKS SHALL BE SEALED WITH A NON-TOXIC INTERLOCK SEALANT. SEE SPECIFICATION SECTION 02351.
- 3.10 THE COFFERDAM SYSTEM IS INTENDED TO PROVIDE A "WATER-TIGHT" SEAL DURING UNWATERING. ALTHOUGH NUISANCE SEEPAGE IS ANTICIPATED, THE AS—CONSTRUCTED COFFERDAM SHOULD BE FREE OF SIGNIFICANT SEEPAGE AND LEAKS. INSTALLATION PRACTICES THAT DECREASE THE WATER—TIGHTNESS WILL NOT BE ACCEPTED.
- 3.11 THE EXISTING LEVEES ARE EXPECTED TO CONSIST OF LOOSE SAND AND MEDIUM STIFF CLAY THAT MAY NOT BE ABLE TO SUPPORT CONCENTRATED EQUIPMENT LOADS, SUCH AS OUTRIGGERS OR WHEEL LOADS. THE CONTRACTOR IS RESPONSIBLE FOR SURFICIAL STABILIZATION OF THE EXCAVATION CONSISTENT WITH THEIR MEANS AND METHODS OF CONSTRUCTION. THIS MAY INCLUDE THE USE OF DUNNAGE; TIMBER MATS; STEEL PLATES; GRAVEL AND FABRIC STABILIZATION PADS; OR OTHER MEASURES PROPOSED BY THE CONTRACTOR.
- 5.12 SHOP DRAWINGS SHALL BE SUBMITTED AS REQUIRED IN THE SPECIFICATIONS. THE PURPOSE OF SHOP DRAWING SUBMITTALS BY THE CONTRACTOR IS TO DEMONSTRATE TO THE ENGINEER THAT HE UNDERSTANDS THE DESIGN CONCEPT BY INDICATING WHICH MATERIAL HE INTENDS TO FURNISH AND INSTALL, AND BY DETAILING THE FABRICATION AND INSTALLATION METHODS HE INTENDS TO USE ON A STAND ALONE SET OF DOCUMENTS. DUPLICATION OF DESIGN DOCUMENTS FOR THE PURPOSE OF SHOP DRAWINGS IS NOT ACCEPTABLE.
- 4 OBSERVATION AND MONITORING
- 4.1 PRIOR TO CONSTRUCTION, THE CONTRACTOR SHALL SUBMIT A WRITTEN PLAN FOR MONITORING LEVEE CONDITIONS DURING SHEET PILE INSTALLATION. SEE SPEC SECTION 02351-3.2 FOR ADDITIONAL INFORMATION.

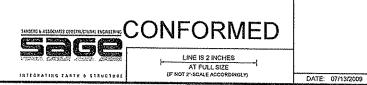


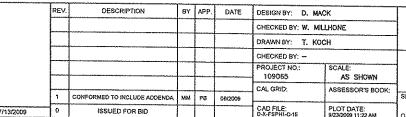



FISH SCREEN STRUCTURE PHASE 2 LEVEES AND COFFERDAMS CONTRA COSTA CANAL, CVPIA, CA

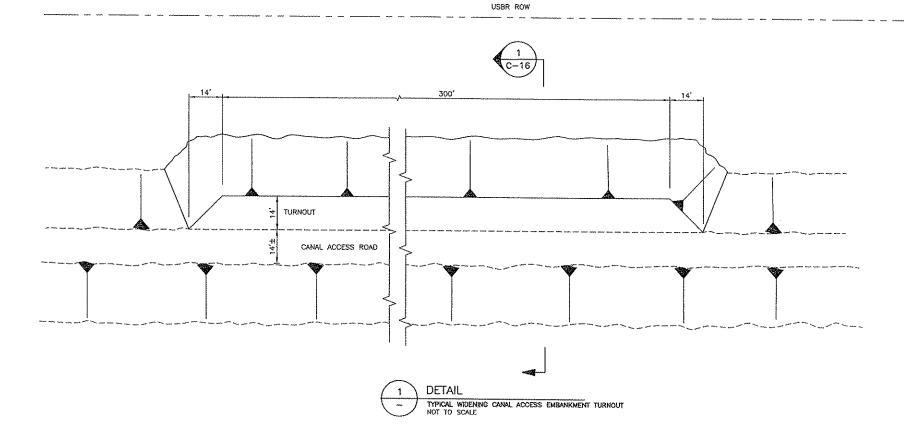

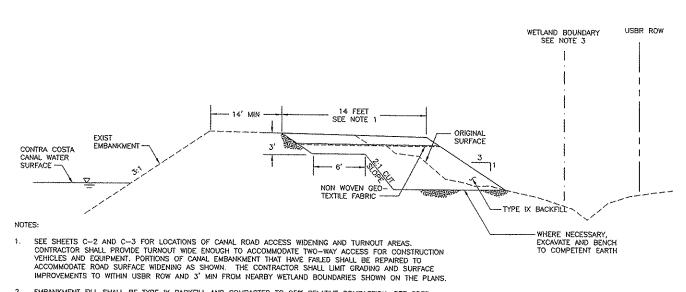

 EMBANKMENT FILL SHALL BE TYPE IX BACKFILL AND COMPACTED TO 95% RELATIVE COMPACTION. SEE SPEC SECTION 02205 AND 02220. CONTRACTOR SHALL NOT GRADE OR DISTURB AREAS DESIGNATED AS WETLAND UNLESS OTHERWISE DIRECTED. CONTRACTOR TO PROTECT WETLAND AREAS TO REMAIN PER SPECIFICATION 01060.



SECTION TYPICAL WIDENING CANAL ROADWAY TURNOUT NOT TO SCALE

BROWN AND CALDWELL

### **CONFORMED**

LINE IS 2 INCHES

AT FULL SIZE
(IF NOT 2"-SCALE ACCORDINGLY)

TCE  BARBED WIRE FENCE SEE NOTE 4	
SNAKE FENCE SEE NOTE 1  1  1  1  1  1  1  1  1  1  1  1  1	BERM, SEE NOTE 3
NOTES:	TYPE V BACKFILL WITH NO ORGANIC MATERIAL


CONTRACTOR SHALL INSTALL ENVIRONMENTAL SNAKE FENCE PER MANUFACTURER SPECIFICATIONS AND RECOMMENDATIONS SNAKE FENCE SHALL BE 40" E-FENCE BY ERTEC ENVIRONMENTAL SYSTEMS OR APPROVED EQUAL.

2. PROVIDE EROSION CONTROL ON BOTH SIDES OF THE SITE PERIMETER BERM.

3. PROVIDE BERM WHERE DESIGNATED ON SHEET G-5.

4. 6 STRAND BARBED WIRE FENCE PER CALTRANS STANDARD PLANS DRAWING NO. A86 AND SPEC SECTION 02445.



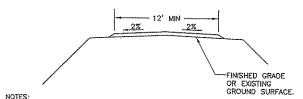

CONTRACTOR SHALL PROVIDE ACCESS ROAD SURFACING ON TOP OF NEW SETBACK LEVEES AND ON EXISTING CANAL ACCESS ROAD AND AT TURNOUTS. ACCESS ROAD SURFACE SHALL BE 6" MIN TYPE 1 BACKFILL COMPACTED TO 95% RELATIVE COMPACTION SEE SPEC SECTIONS 02205 AND 02220.

5	DETAIL
	ACCESS ROAD SURFACING NOT TO SCALE


REV.	DESCRIPTION	BY	APP.	DATE	DESIGN BY: M. W	AHER	Ι
					CHECKED BY: P. B	ELLOWS	
					DRAWNBY: F. B	URKE	7
					CHECKED BY: C. J	OYCE	FIS
					PROJECT NO.: 109065	SCALE: AS SHOWN	00
		<u> </u>			CAL GRID:	ASSESSOR'S BOOK:	<b>1</b>


CONTRA COSTA WATER DISTRICT CONCORD, CALIFORNIA

FISH SCREEN STRUCTURE PHASE 2 LEVEES AND COFFERDAMS CONTRA COSTA CANAL, CVPIA, CA BERM ACCESS ROAD 1

DRAWING CONSULTANT REV. 21 D-13045 | C-16

PLOT DATE: 9/23/2009 11:22 AM CAD FILE: D-X-FSPH1-C-18 DATE: 07/13/2009 0 ISSUED FOR BID

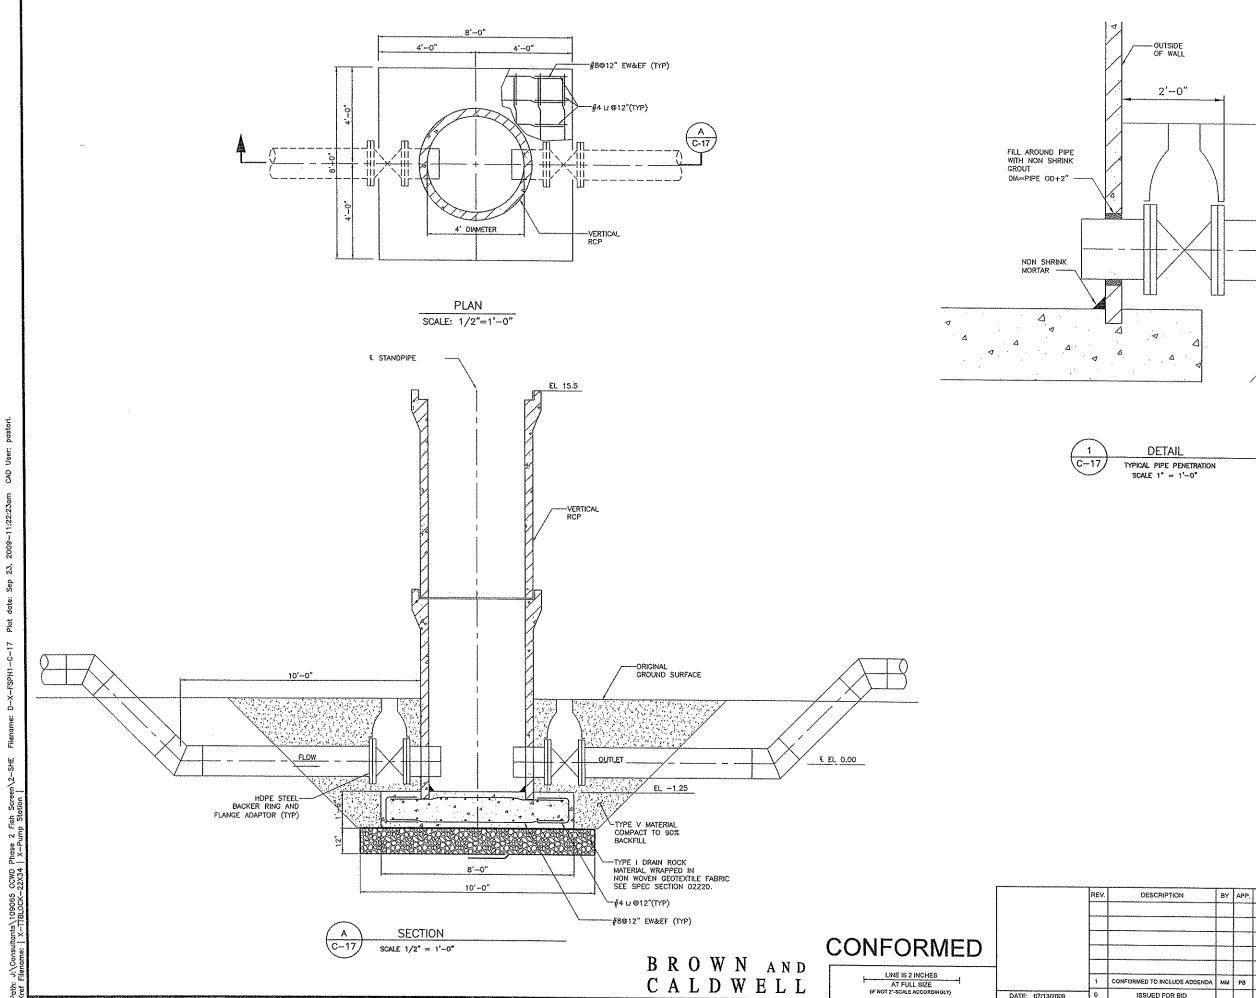

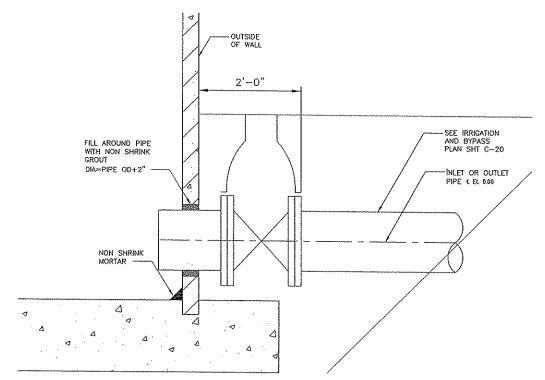

DATE DESIGN BY: M. MAHER CHECKED BY: P. BELLOWS DRAWN BY: F. BURKE CHECKED BY: C. JOYCE PROJECT NO.; 109065 AS SHOWN CAL GRID: ASSESSOR'S BOOK: CONFORMED TO INCLUDE ADDENDA 08/2009 CAD FILE: D-X-FSPH1-C-17 DATE: 07/13/2009 ISSUED FOR BID

CONTRA COSTA WATER DISTRICT CONCORD, CALIFORNIA

FISH SCREEN STRUCTURE PHASE 2
LEVES AND COFFERDAMS
CONTRA COSTA CANAL, CYPIA, CA
CMIL DETAILS 2 IRRIGATION
STANDPIPE
HEET DRAWING CONSULTANT REV.
NO. NO. NO.
F 28 D-13046 C-17 O

SHEET 22 OF 28

CONTRA COSTA


WATER DISTRICT

FISH SCREEN STRUCTURE PHASE 2 LEVEES AND COFFERDAMS CONTRA COSTA CANAL, CVPIA, CA

CIVIL DETAILS 3


D-13047 | C-18

DRAWING NO.

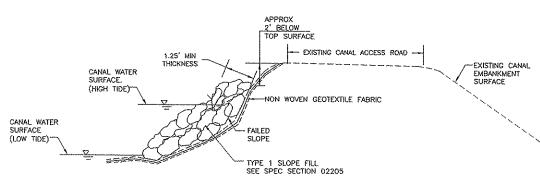

- SEE DRAWING C-2 AND C-3 FOR POTENTIAL AREAS REQUIRING SLOPE STABILIZATION ALONG CANAL ACCESS ROAD.
- 2. MAXIMUM SLOPE OF REPAIRED EMBANKMENT SHALL BE NO STEEPER THAN 2H:1V.



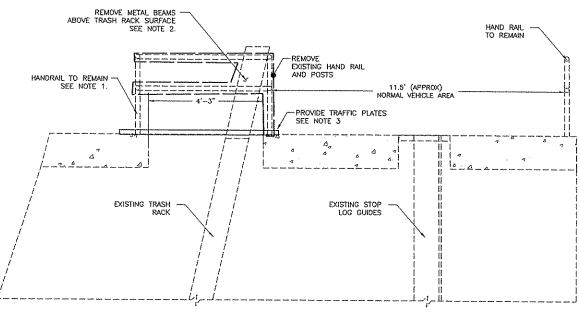


- CONTRACTOR SHALL REMOVE PORTION OF HAND RAIL SURROUNDING EXISTING METAL BEAMS ABOVE ROCK SLOUGH TRASH RACK SURFACE.
- REMOVE PORTION OF TRASH RACK STRUCTURE ABOVE CONCRETE SURFACE. CUT 3" BELOW CONCRETE SURFACE.
- CONTRACTOR SHALL PROVIDE TRAFFIC PLATING
  TO ALLOW CONSTRUCTION VEHICLES TO TRAVEL OVER TRASH RACK.
  TRAFFIC PLATING SHALL BE RATED FOR H—20 LOAD AND SHALL BE
  LEFT IN PLACE AFTER CONSTRUCTION.
- 4. SEE PHOTO 2, THIS SHEET.
- PHASE 3: CONTRACTOR SHALL REPLACE HANDRAIL IN KIND AT ORIGINAL LOCATION AFTER CONSTRUCTION AND REMOVE TRAFFIC
- TRASH RACK CROSSING SHALL BE 1 LANE CROSSING WITH ONLY 1 VEHICLE ON THE TRASH RACK AT ANY TIME.

DETAIL ROCK SLOUGH TRASH RACK DEMOLITION NOT TO SCALE

BROWN AND CALDWELL



TYPICAL CANAL EMBANKMENT SLOPE FAILURE AT LOW TIDE

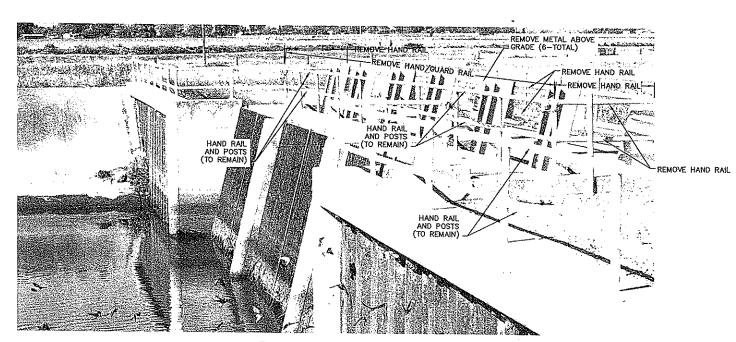


TRASH RACK MODIFICATIONS TO ALLOW CONSTRUCTION TRUCK MOVEMENT




		REV.	DESCRIPTION	BY	APP.	DATE	DESIGN BY: M. MA	HER	
							CHECKED BY: P. BE	LLOWS	
ŀ							DRAWN BY: F. BU	RKE	***************************************
Ì							CHECKED BY: C. JO	YCE	FISH
		<u> </u>					PROJECT NO.: 109065	SCALE: AS SHOWN	CON
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2 DETAIL
VAR BOLLARD
NOT TO SCALE

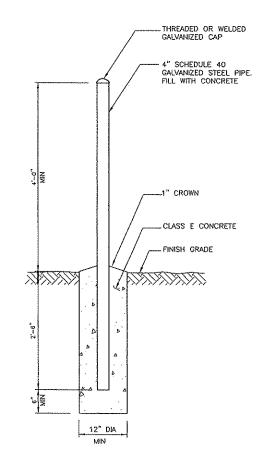

- CONTRACTOR SHALL PROVIDE SUMP DRAINAGE AT LOCAL LOW POINTS LOCATED ON THE PLANS. CONTRACTOR SHALL PROVIDE DRAINAGE PUMPS (APPROX. 200 GPM) TO BE SET IN SUMP BARREL. CONTRACTOR SHALL SUPPLY ELECTRIC POWER AS NEEDED FOR SUMP PUMPS. GRADE SURROUNDING AREA TO DRAIN TO SUMPS.
- FIBER ROLLS SHALL BE INSPECTED BEFORE AND AFTER STORM EVENTS AND REPLACED AS NEEDED TO PROVIDE FILTERING OF SURFACE RUNOFF.

3 DETAIL
VAR SITE DRAINAGE SUMP

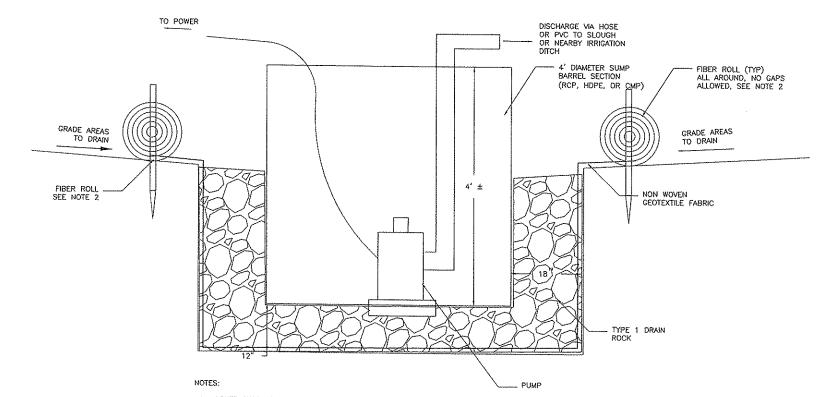CONFORMED

DESCRIPTION BY APP. DATE DESIGN BY: M. MAHER CHECKED BY: P. BELLOWS DRAWN BY: F. BURKE CHECKED BY: C. JOYCE PROJECT NO.: 109065 AS SHOWN CAL GRID: ASSESSOR'S BOOK: CONFORMED TO INCLUDE ADDENDA 08/2009 PLOT DATE: 9/23/2009 11:22 AM CAD FILE: D-X-FSPH1-C-19 DATE: 07/13/2009 ISSUED FOR BID

CONTRA COSTA
WATER DISTRICT
CONCORD, CALIFORNIA

FISH SCREEN STRUCTURE PHASE 2 LEVEES AND COFFERDAMS CONTRA COSTA CANAL, CYPIA, CA

CIVIL DETAILS 4


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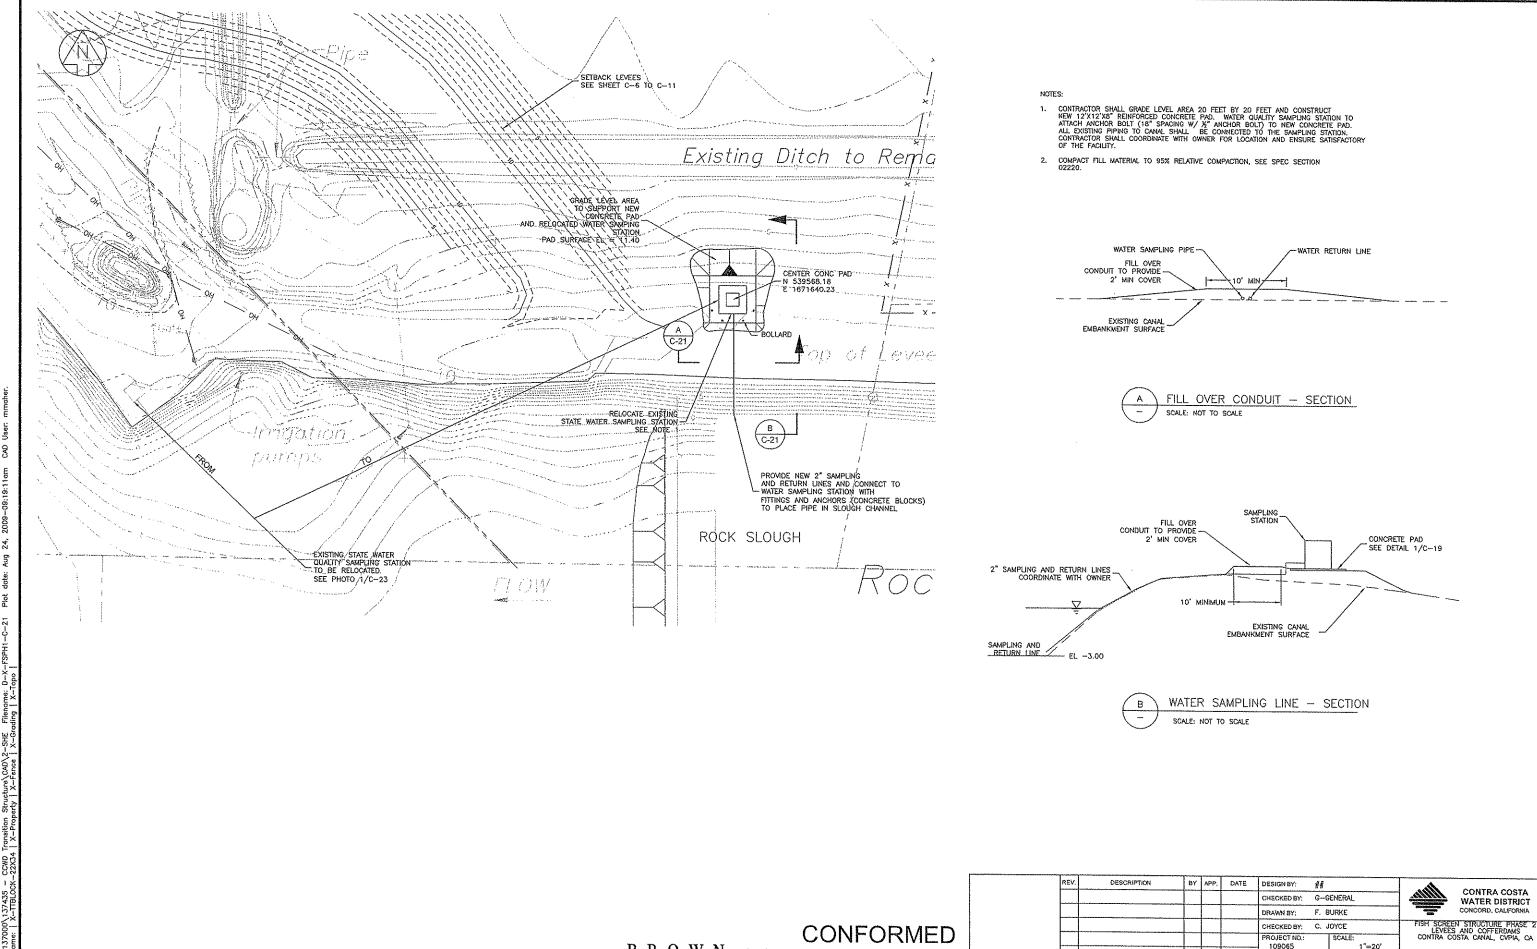
BROWN AND CALDWELL

LINE IS 2 INCHES

AT FULL SIZE
(IF NOT 2"-SCALE ACCORDINGLY)

fish Screen\2-SHE Flename: 0-X-FSPH1-C-19 Plot date: Sep 23



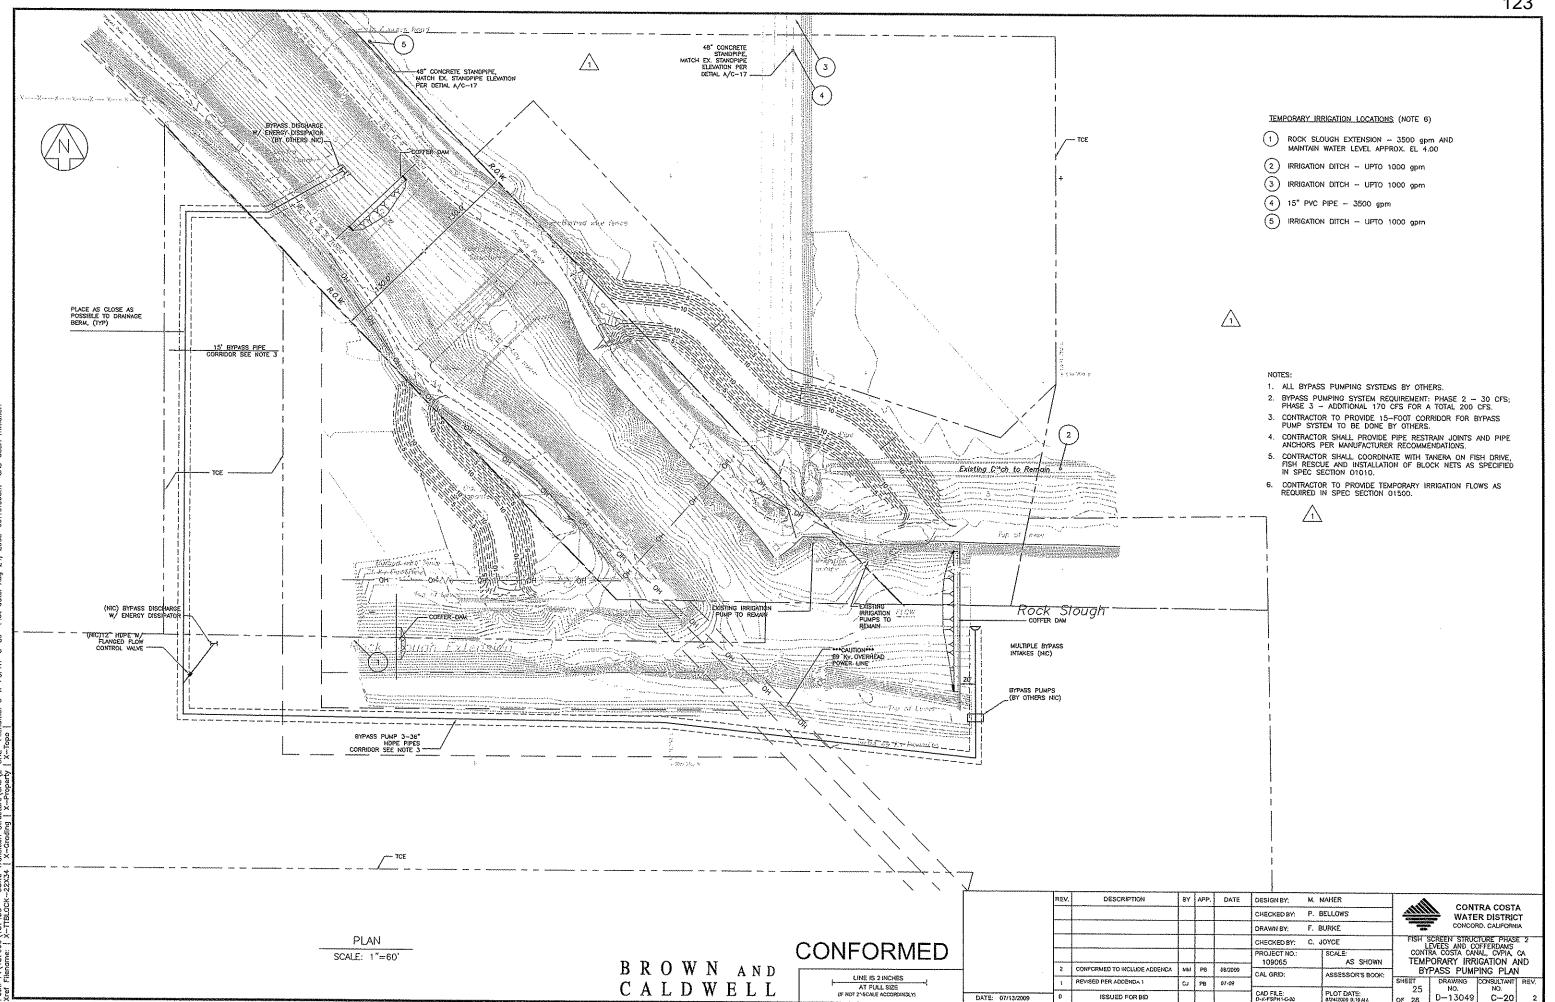


BROWN AND CALDWELL


LINE IS 2 INCHES AT FULL SIZE (IF NOT 2"-SCALE ACCORDINGLY)

109065 1"=20' CAL GRID: ASSESSOR'S BOOK CONFORMED TO INCLUDE ADDENDA MM PB 06/2009 CAD FILE: D-K-FSPH1-C-2 PLOT DATE: 8/24/2009 8:19 AV ISSUED FOR BID

WATER QUALITY STATION

DRAWING CONSULTANT REV. NO. NO. D-13050 C-21 1

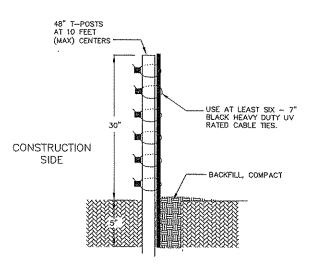


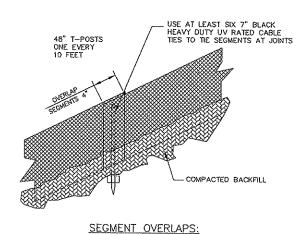





#### SNAKE FENCE NOTES:

- 1. MATERIAL SHALL BE ERTEC, E-FENCE AND SHALL HAVE AN UNIT WEIGHT OF 0.16-0.19 LBS/SQFT.
- 2. FUNCTIONAL LIFE SHALL BE 6 YEARS MINIMUM.
- 3. SEGMENTS SHALL BE 100FT LONG.
- 4. MATERIAL SHALL BE RECYCLABLE AS #2 HDPE.
- 5. TENSILE STRENGTH SHALL BE 400 LBS PER ASTM 04595.
- 6. UV STABILITY SHALL BE 96% PER ASTM 04355.
- 7. STRAND DEFORMITY SHALL BE 0.375" AT 38 LBS PULL THROUGH AT 68" (F).
- 8. SERVICE TEMPERATURE SHALL BE -30 TO 160 DEGREES (F).

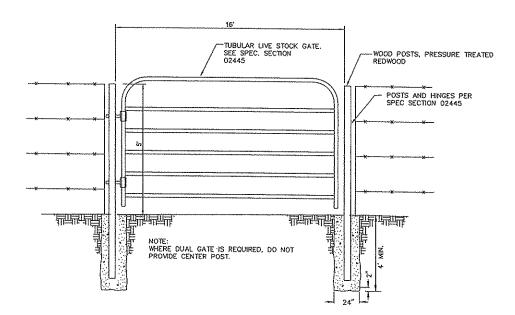

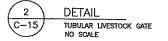

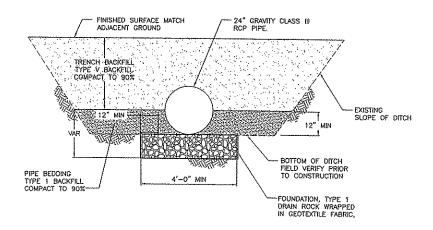



**CONFORMED** 

BROWN AND


CALDWELL

LINE IS 2 INCHES

AT FULL SIZE
(IF NOT 2"-SCALE ACCORDINGLY)

DESCRIPTION BY APP. DATE DESIGN BY: M. MAHER CONTRA COSTA CHECKED BY: P. BELLOWS WATER DISTRICT DRAWN BY: F. BURKE CONCORD, CALIFORNIA FISH SCREEN STRUCTURE PHASE 2' LEVEES AND COFFERDAMS CONTRA COSTA CANAL, CVPIA, CA CHECKED BY: C. JOYCE PROJECT NO. 109065 AS SHOWN FENCING DETAILS CAL GRID: ASSESSOR'S BOOK SHEET 27 OF 28 DRAWING CONSULTANT REV. NO. NO. C-22 1 CONFORMED TO INCLUDE ADDENDA MM CAD FILE: D-X-FSPHI-C-22 PLOT DATE: 9/23/2009 11:23 AM DATE: 07/13/2009 ISSUED FOR BID

PHOTO 1

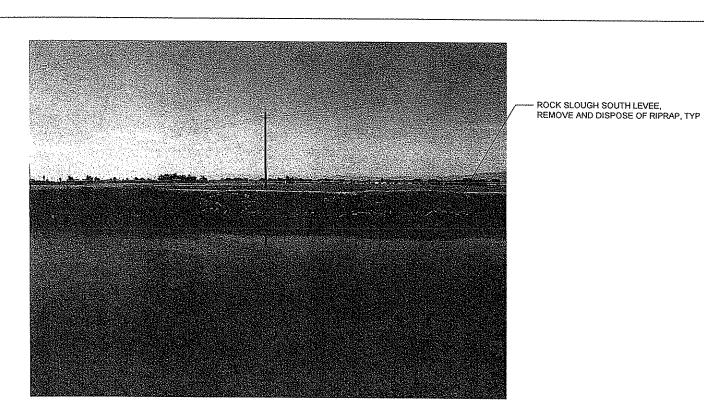

РНОТО (3)


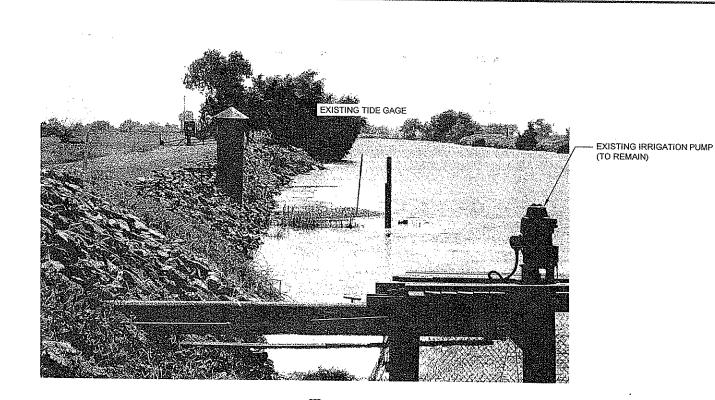


PHOTO (2)

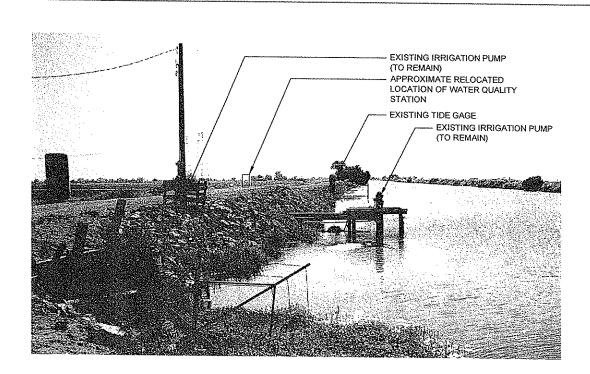

РНОТО (4)


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	REV.	DESCRIPTION	BY	APP.	DATE	DESIGN BY:	M.	MAHER	T
						CHECKED BY:	P.	BELLOWS	1
						DRAWN BY:	F.	BURKE	1
						CHECKED BY:	C.	JOYCE	T
						PROJECT NO.: 109065	*******	SCALE: NO SCALE	1
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CONTRA COSTA WATER DISTRICT CONCORD, CALIFORNIA

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BROWN AND CALDWELL




nsultants\109065 CCWD Phase 2 Fish Screen\2-SHE Filename: D-X-FSFH ne: | X-TTBLOCK-22X34 | X-Sections and Profile | DAM_CA |

1° = 10' V CONFORMED
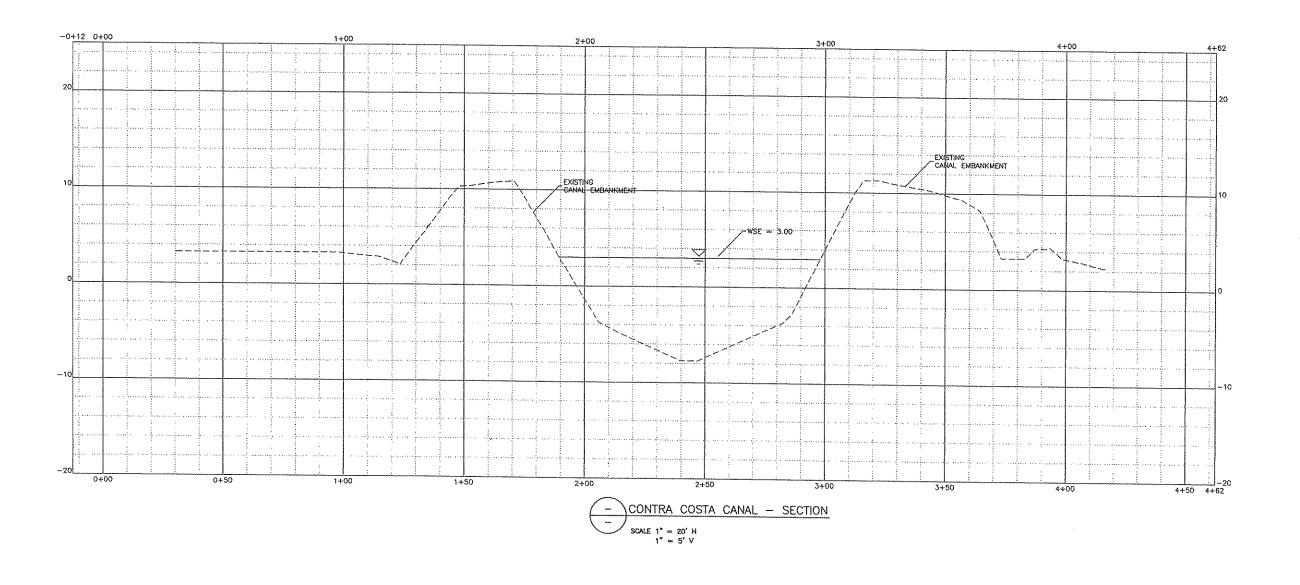
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						CHECKED BY:	G-GENERAL	CONTRA COSTA WATER DISTRICT CONCORD, CALIFORNIA
						DRAWN BY:	BC	CONCORD, CALIFORNIA
						CHECKED BY:	KK	HARM SEELEN JUHUN HAR HEEL GVEES
						PROJECT NO.: 109065	SCALE: AS SHOWN	CONTRACE COSTA XANA, CAA
						CAL GRID:	ASSESSOR'S BOOK:	CONTRA COSTA CANAL SECTION
								SHEET DRAWING CONSULTANT REV.
DATE: 07/13/2009	0	ISSUED FOR BID				CAD FILE: D-X-FSPH1-C-12	PLOT DATE: 9/23/2009 11:21 AM	VALUE NO. NO. OF 28 VALUE C-12

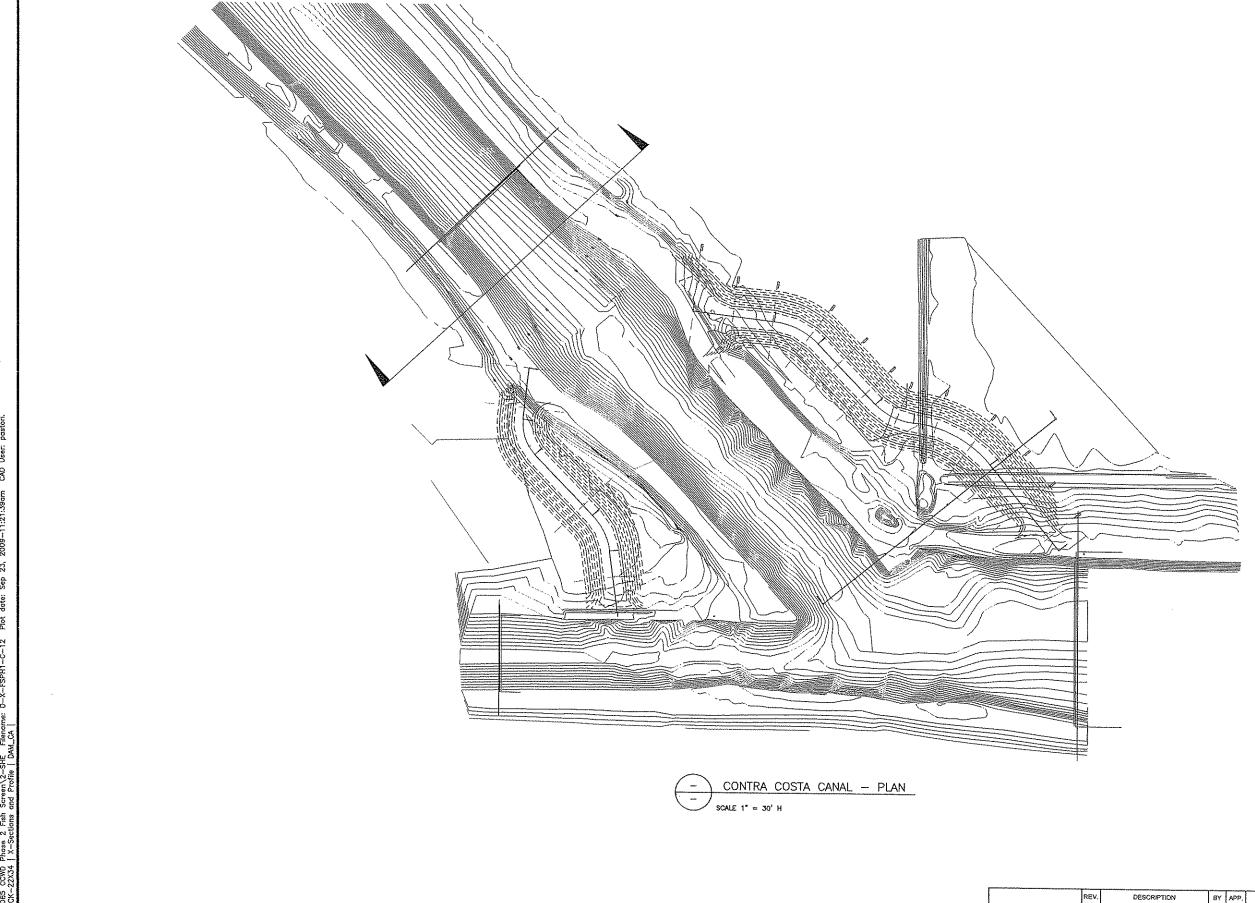

1° = 10' V CONFORMED

LINE IS 2 INCHES

AT FULL SIZE
(IF NOT 2"SCALE ACCORDINGLY)

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CONTRA COSTA WATER DISTRICT CONCORD, CALIFORNIA